

MAP REFERENCES:

- "RIGHT OF WAY PLAN SHOWING EASEMENTS TO BE ACQUIRED FROM CONGREGATION B'NAI JACOB BY THE CONNECTICUT LIGHT & POWER COMPANY, TOWN OF WOODBRIDGE, NEW HAVEN COUNTY, CONNECTICUT" DATED JULY 6, 2010, ON FILE AS MAP 720 IN THE TOWN OF WOODBRIDGE LAND RECORDS.
- "CONNECTICUT STATE HIGHWAY DEPARTMENT RIGHT OF WAY MAP, TOWN OF WOODBRIDGE, RIMMON ROAD FROM BEECHER ROAD EASTERLY TO THE ANSONIA ROAD", DATED 6/14/1940, SCALE 1"=40', ON FILE AS MAP 140 IN THE TOWN OF WOODBRIDGE LAND RECORDS.

Rev	Date	Description
2	1/19/2026	Wetland Flag 20
1	10/21/2025	Name Change

THIS MAP IS NOT VALID UNLESS IT HAS A
LIVE SIGNATURE AND EMBOSSED SEAL
OF KEVIN M. CROWLEY.


TO MY KNOWLEDGE AND BELIEF, THIS
MAP IS SUBSTANTIALLY CORRECT TO THE
STANDARDS OF CLASS 'A2' AS NOTED
HEREON.

Kevin M. Crowley
KEVIN M. CROWLEY
R.L.S. # 70261

27 BEECHER ROAD
WOODBRIDGE, CONNECTICUT

PREPARED FOR:
BEECHER ROAD, LLC

SCALE 1" = 40' 24 JANUARY 2025
FE24-1928






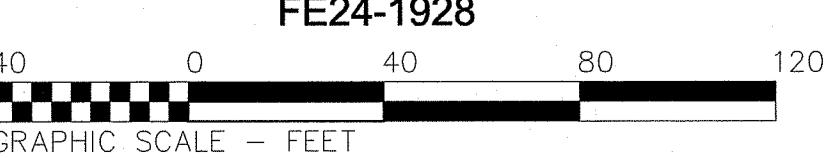


NOTES:

1. THIS PLAN IS FOR THE PROPOSED 100 UNIT RESIDENTIAL BUILDING WITH PARKING, UTILITIES, AND MISCELLANEOUS SITE IMPROVEMENTS. THIS PLAN IS NOT TO BE USED AS A SITE OR CONSTRUCTION PLAN. ADDITIONAL DESIGN AND DETAILS ARE REQUIRED FOR BIDDING AND CONSTRUCTION.
2. THE CONTRACTOR SHALL LOCATE AND VERIFY THE SIZE, LOCATION, DEPTH AND INVERTS OF ANY AND ALL EXISTING UTILITIES PRIOR TO COMMENCING OPERATIONS. THE CONTRACTOR SHALL ALSO BE REQUIRED TO CONTACT THE TOLL FREE "CALL-BEFORE-YOU-DIG" PHONE NUMBER AT 1-800-922-4455.
3. THE PROPOSED DEVELOPMENT SHOWN HEREON WILL REQUIRE REVIEW AND APPROVAL BY THE VARIOUS AGENCIES OF WOODBRIDGE.
4. RESTORE ALL DISTURBED AREAS WITH A MINIMUM OF FOUR (4") INCHES OF TOPSOIL, SEED, AND HAY MULCH UPON COMPLETION OF CONSTRUCTION.
5. LOT SERVED BY TOWN SEWER SYSTEM AND PUBLIC WATER SUPPLY.
6. ANY ACTIVITY, PRESENT OR FUTURE, WHICH INVOLVES CLEARING, REGRADING, FILLING, CONSTRUCTION, OR ANY OTHER MEANS OF DISTURBANCE WITHIN THE WETLANDS OR THE 100' UPLAND REVIEW AREA IS PROHIBITED WITHOUT THE PRIOR CONSENT OF THE TOWN'S INLAND WETLAND AGENCY

MAP REFERENCES:

A. LOCATION OF EXISTING OUT STRUCTURES, AND TOPOGRAPHY WERE OBTAINED FROM A SURVEY TITLED "IMPROVEMENT LOCATION PLAN, 27 BEECHER ROAD, WOODBRIDGE, CONNECTICUT, PREPARED FOR LUCIANI PROPERTIES, LLC", DATED 25 JANUARY 2025, SCALE 1"=50', BY FULLER ENGINEERING & LAND SURVEYING, LLC.

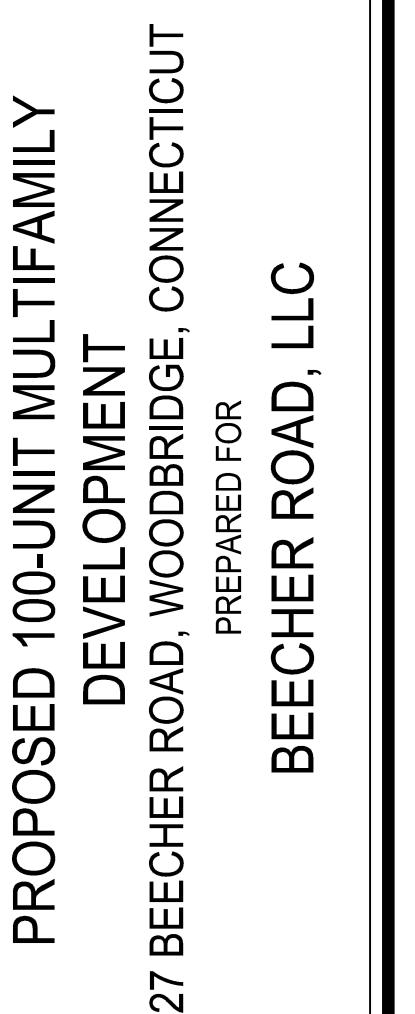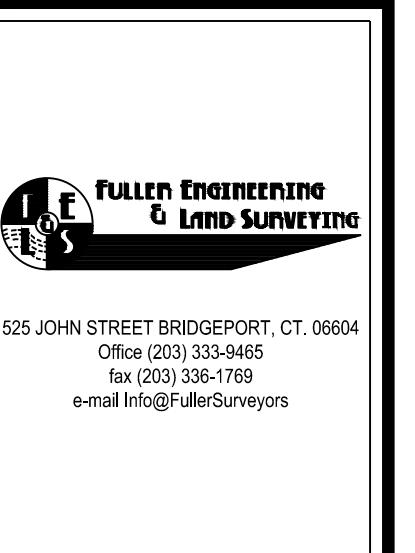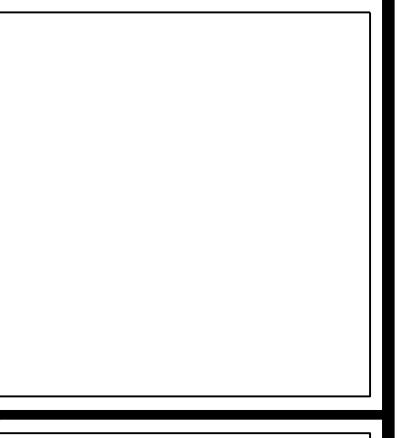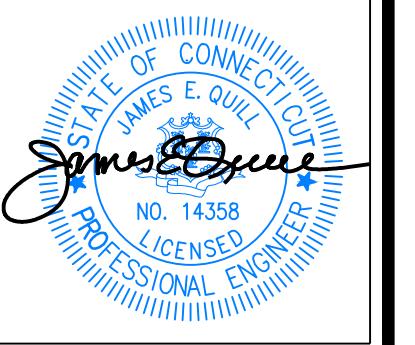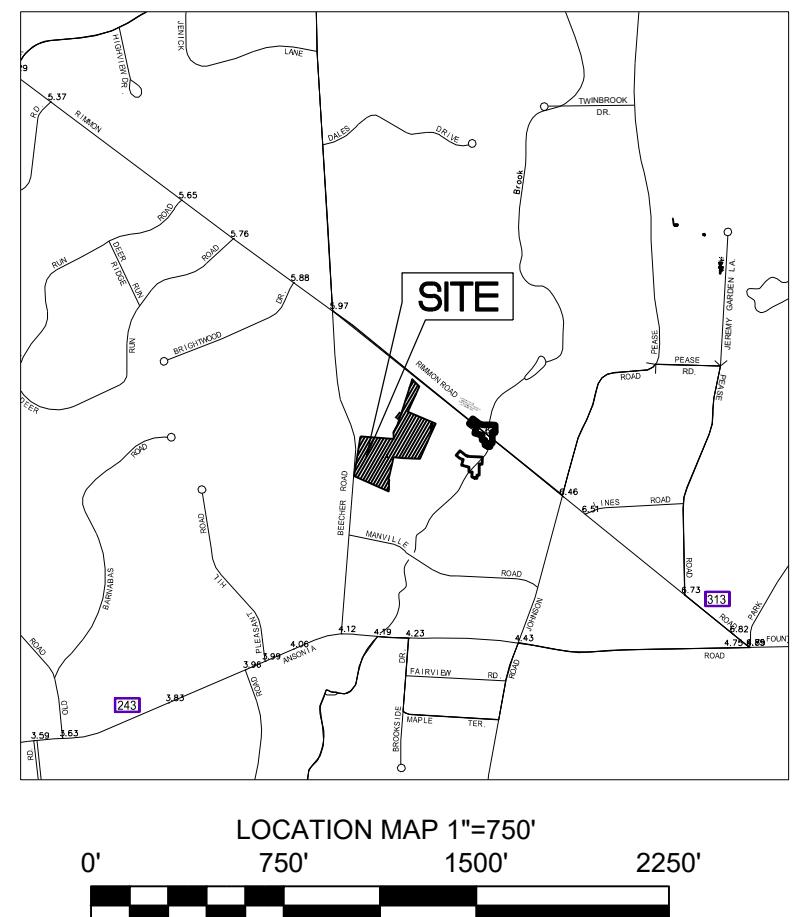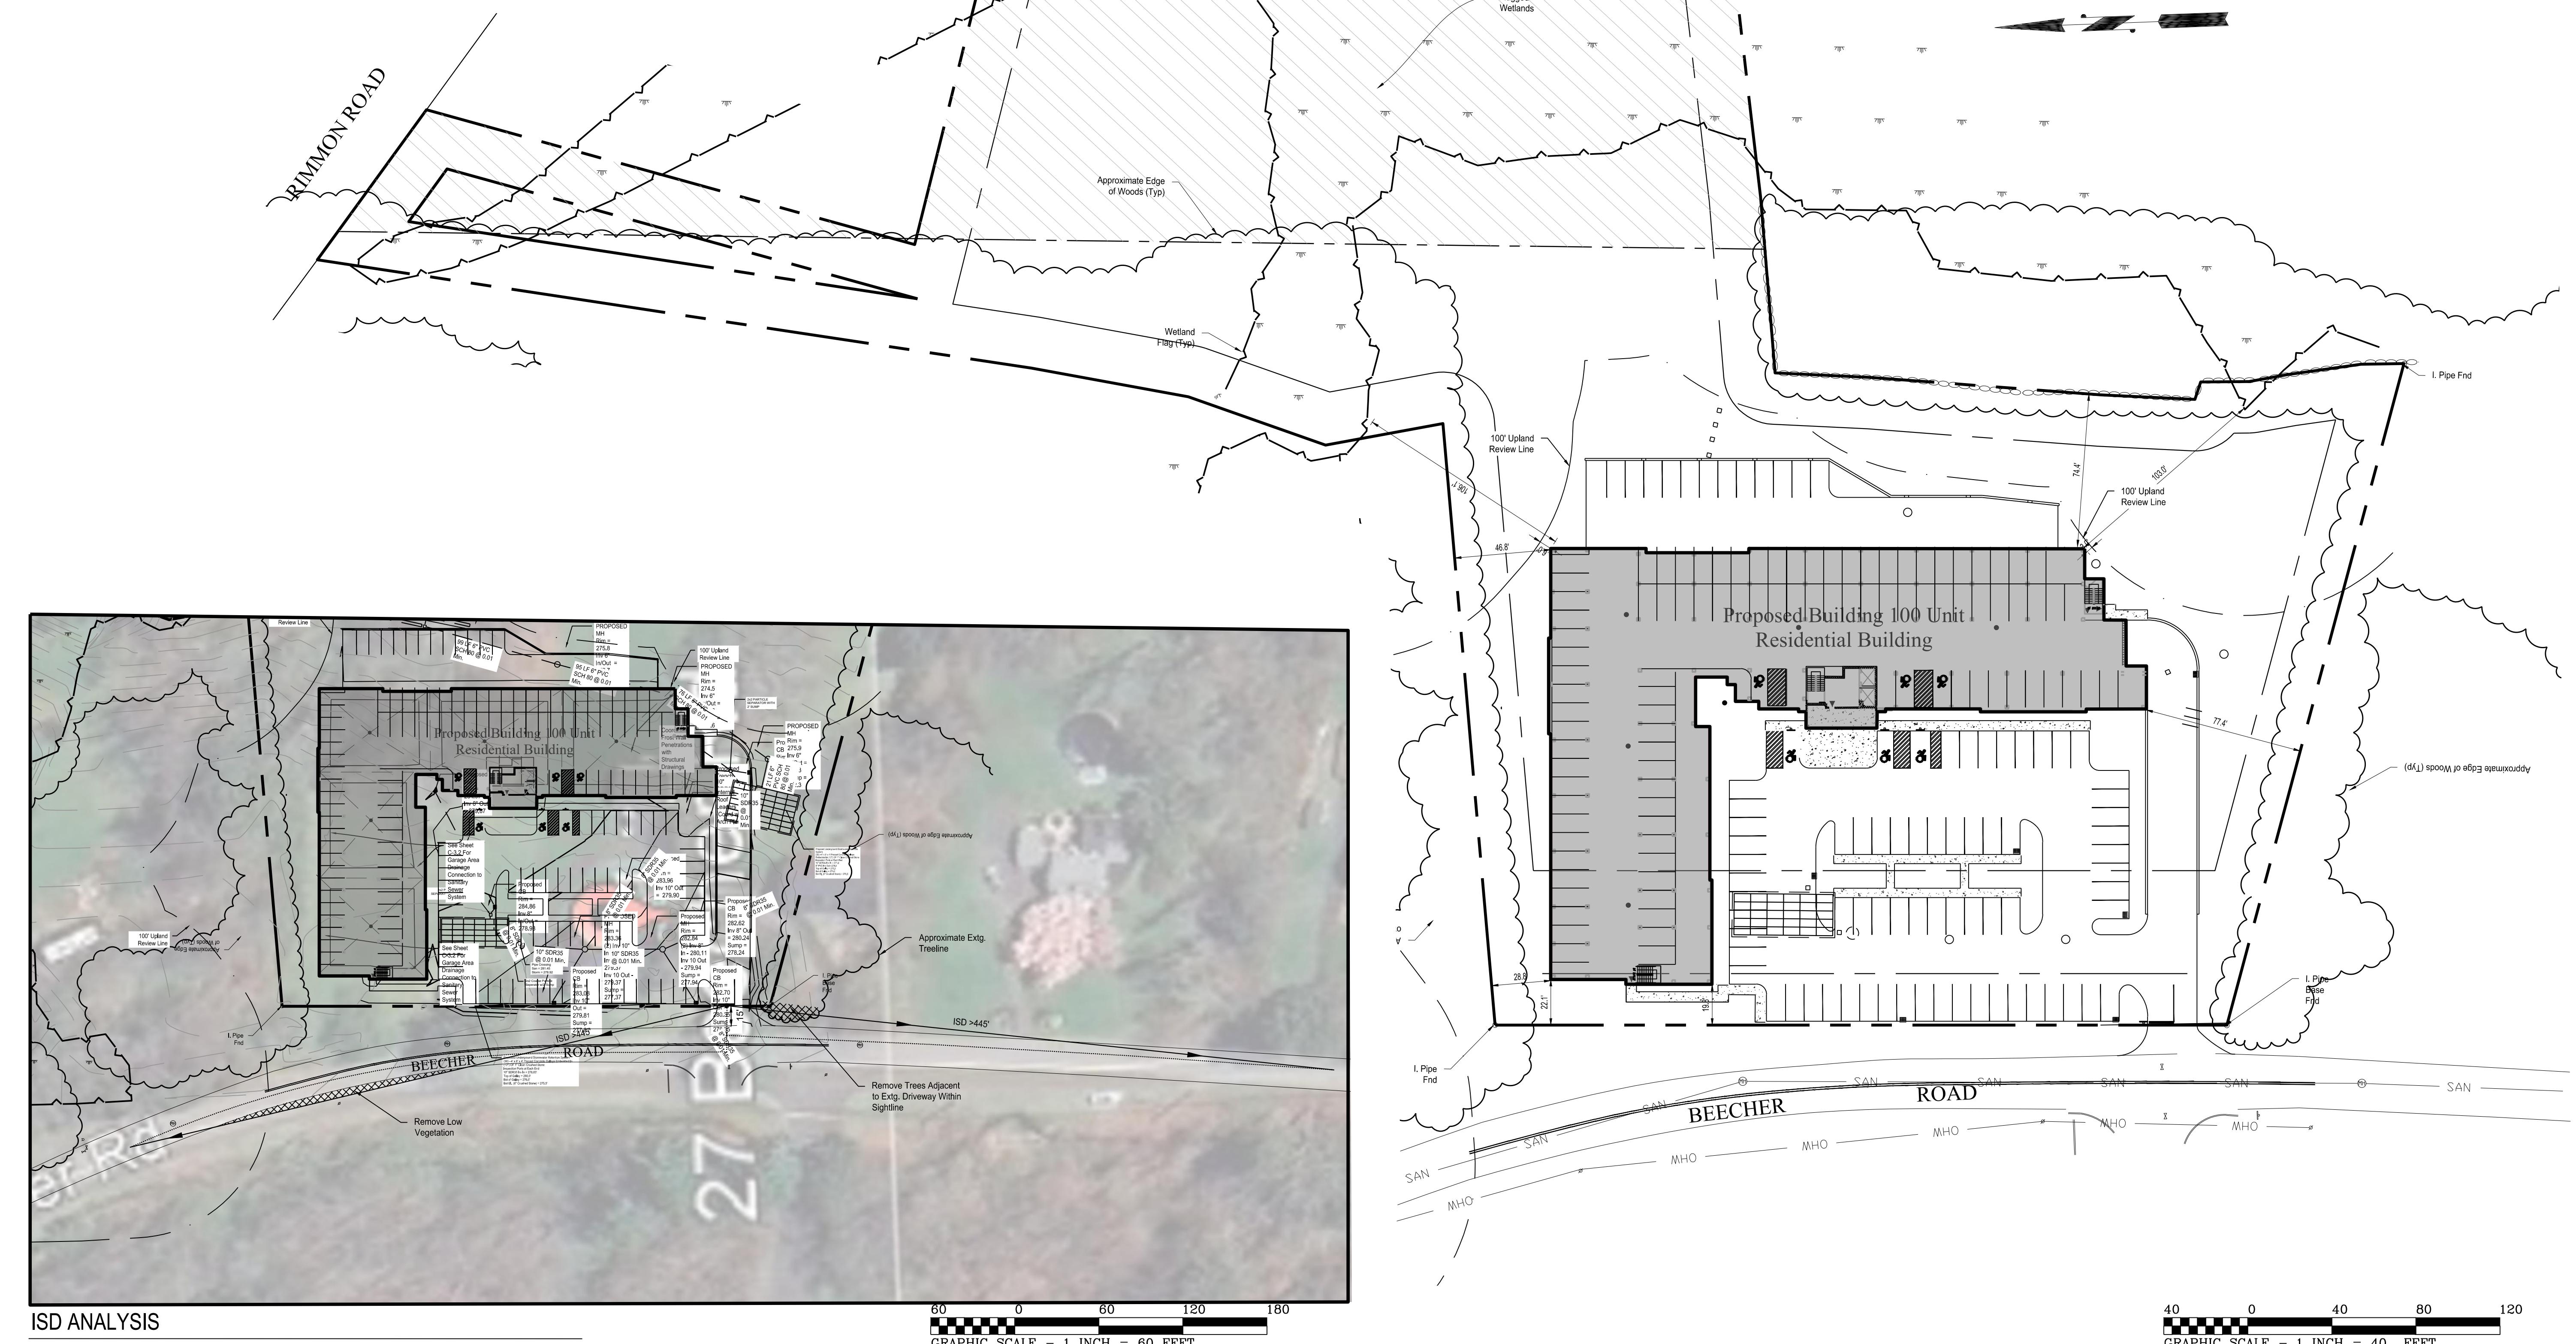

Job Number:
FE25-1960

Job Start Date:
4-15-25

Rev	Date

Staff Comments 1/19/26
Level Spreader Mod 11/20/25
Issue IW 10/22/25

Drawn By: Checked By:
D.R.R. J.E.Q.


Sheet Title:
PROPOSED SITE PLAN

Scale:
1" = 40'

Sheet Number:
C-2.1



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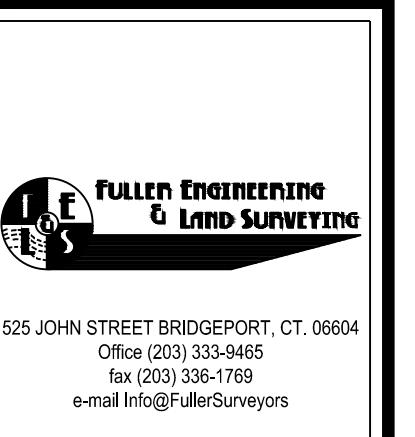


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PROPOSED 100-UNIT MULTIFAMILY
DEVELOPMENT
27 BEECHER ROAD, WOODBRIDGE, CONNECTICUT
PREPARED FOR
BEECHER ROAD, LLC

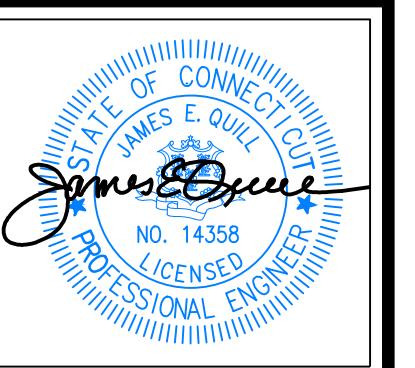Job Number:
FE25-1960

Job Start Date:


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Drawn By: Checked By:
D.R.R. J.E.Q.

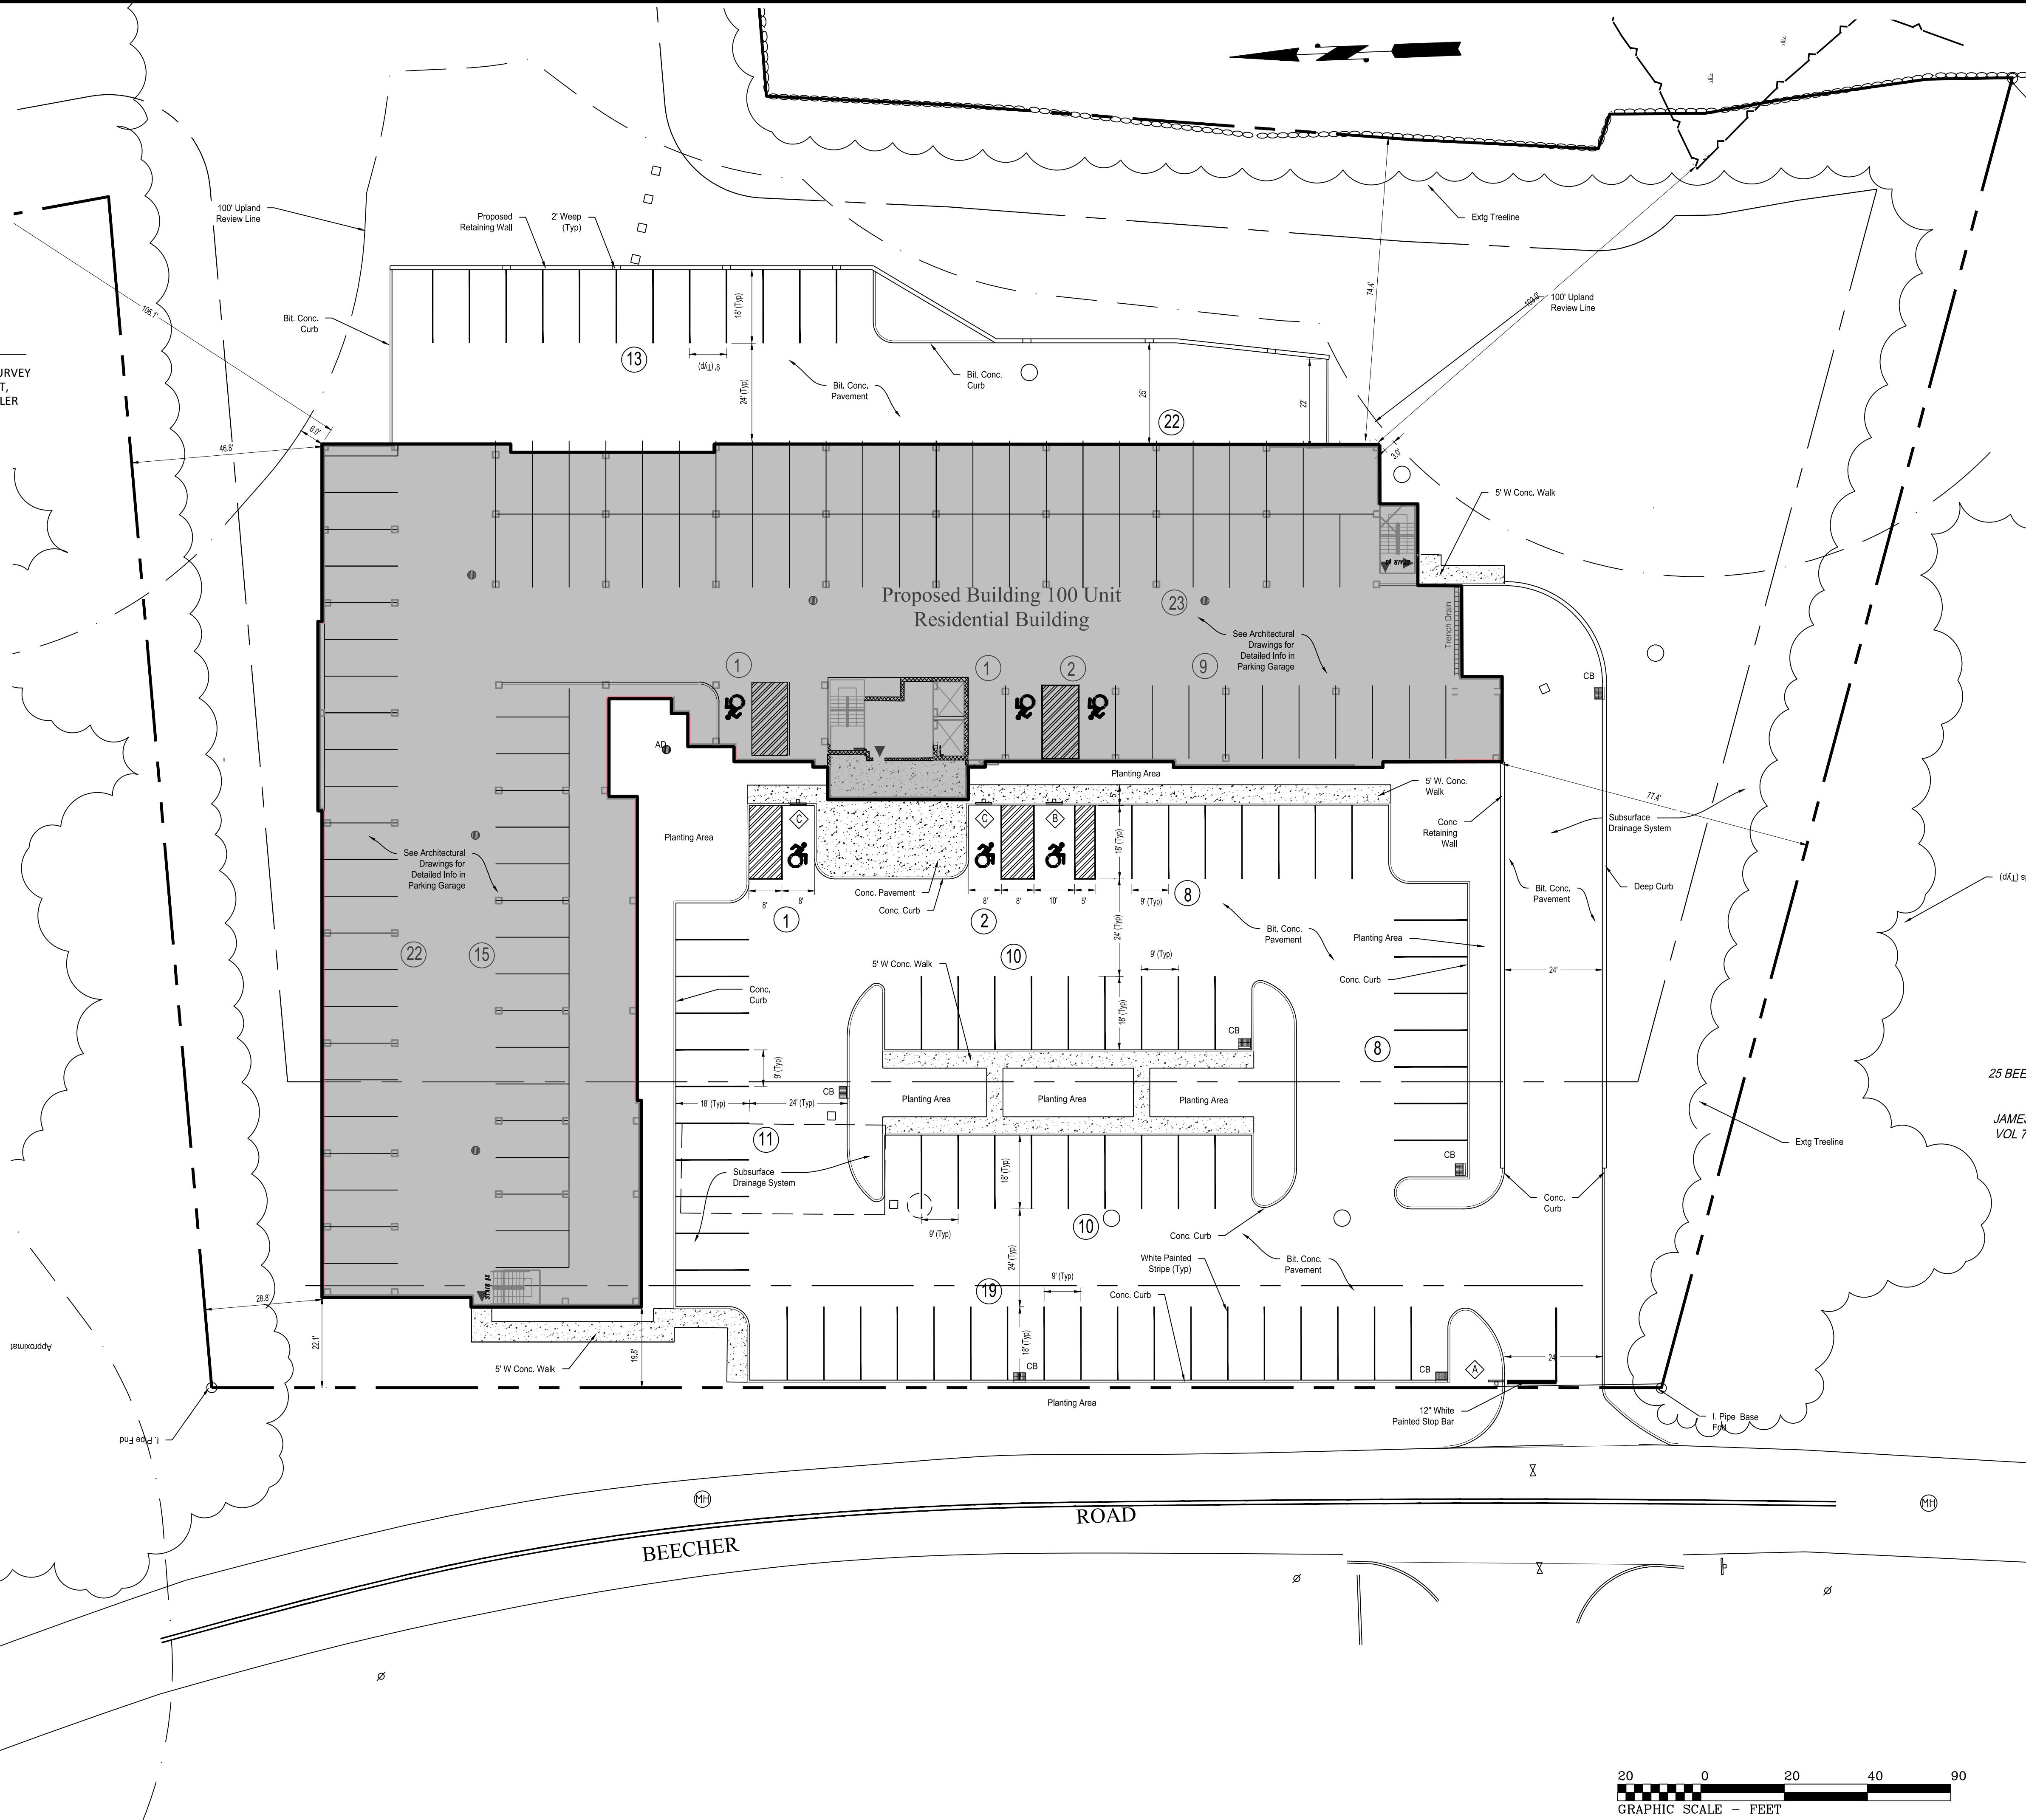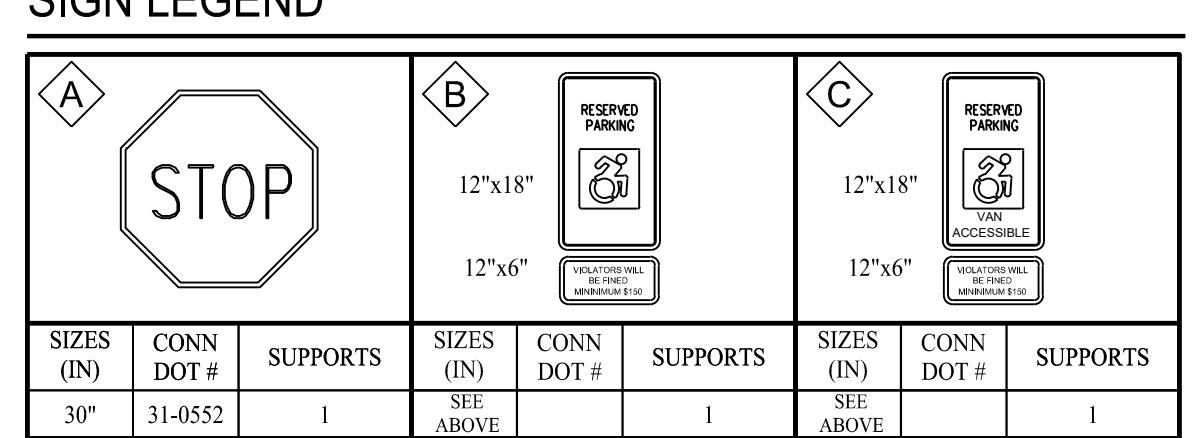Sheet Title:
**PROPOSED SITE
PLAN
ENLARGEMENT**


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1" = 20'

Sheet Number:
C-2.2

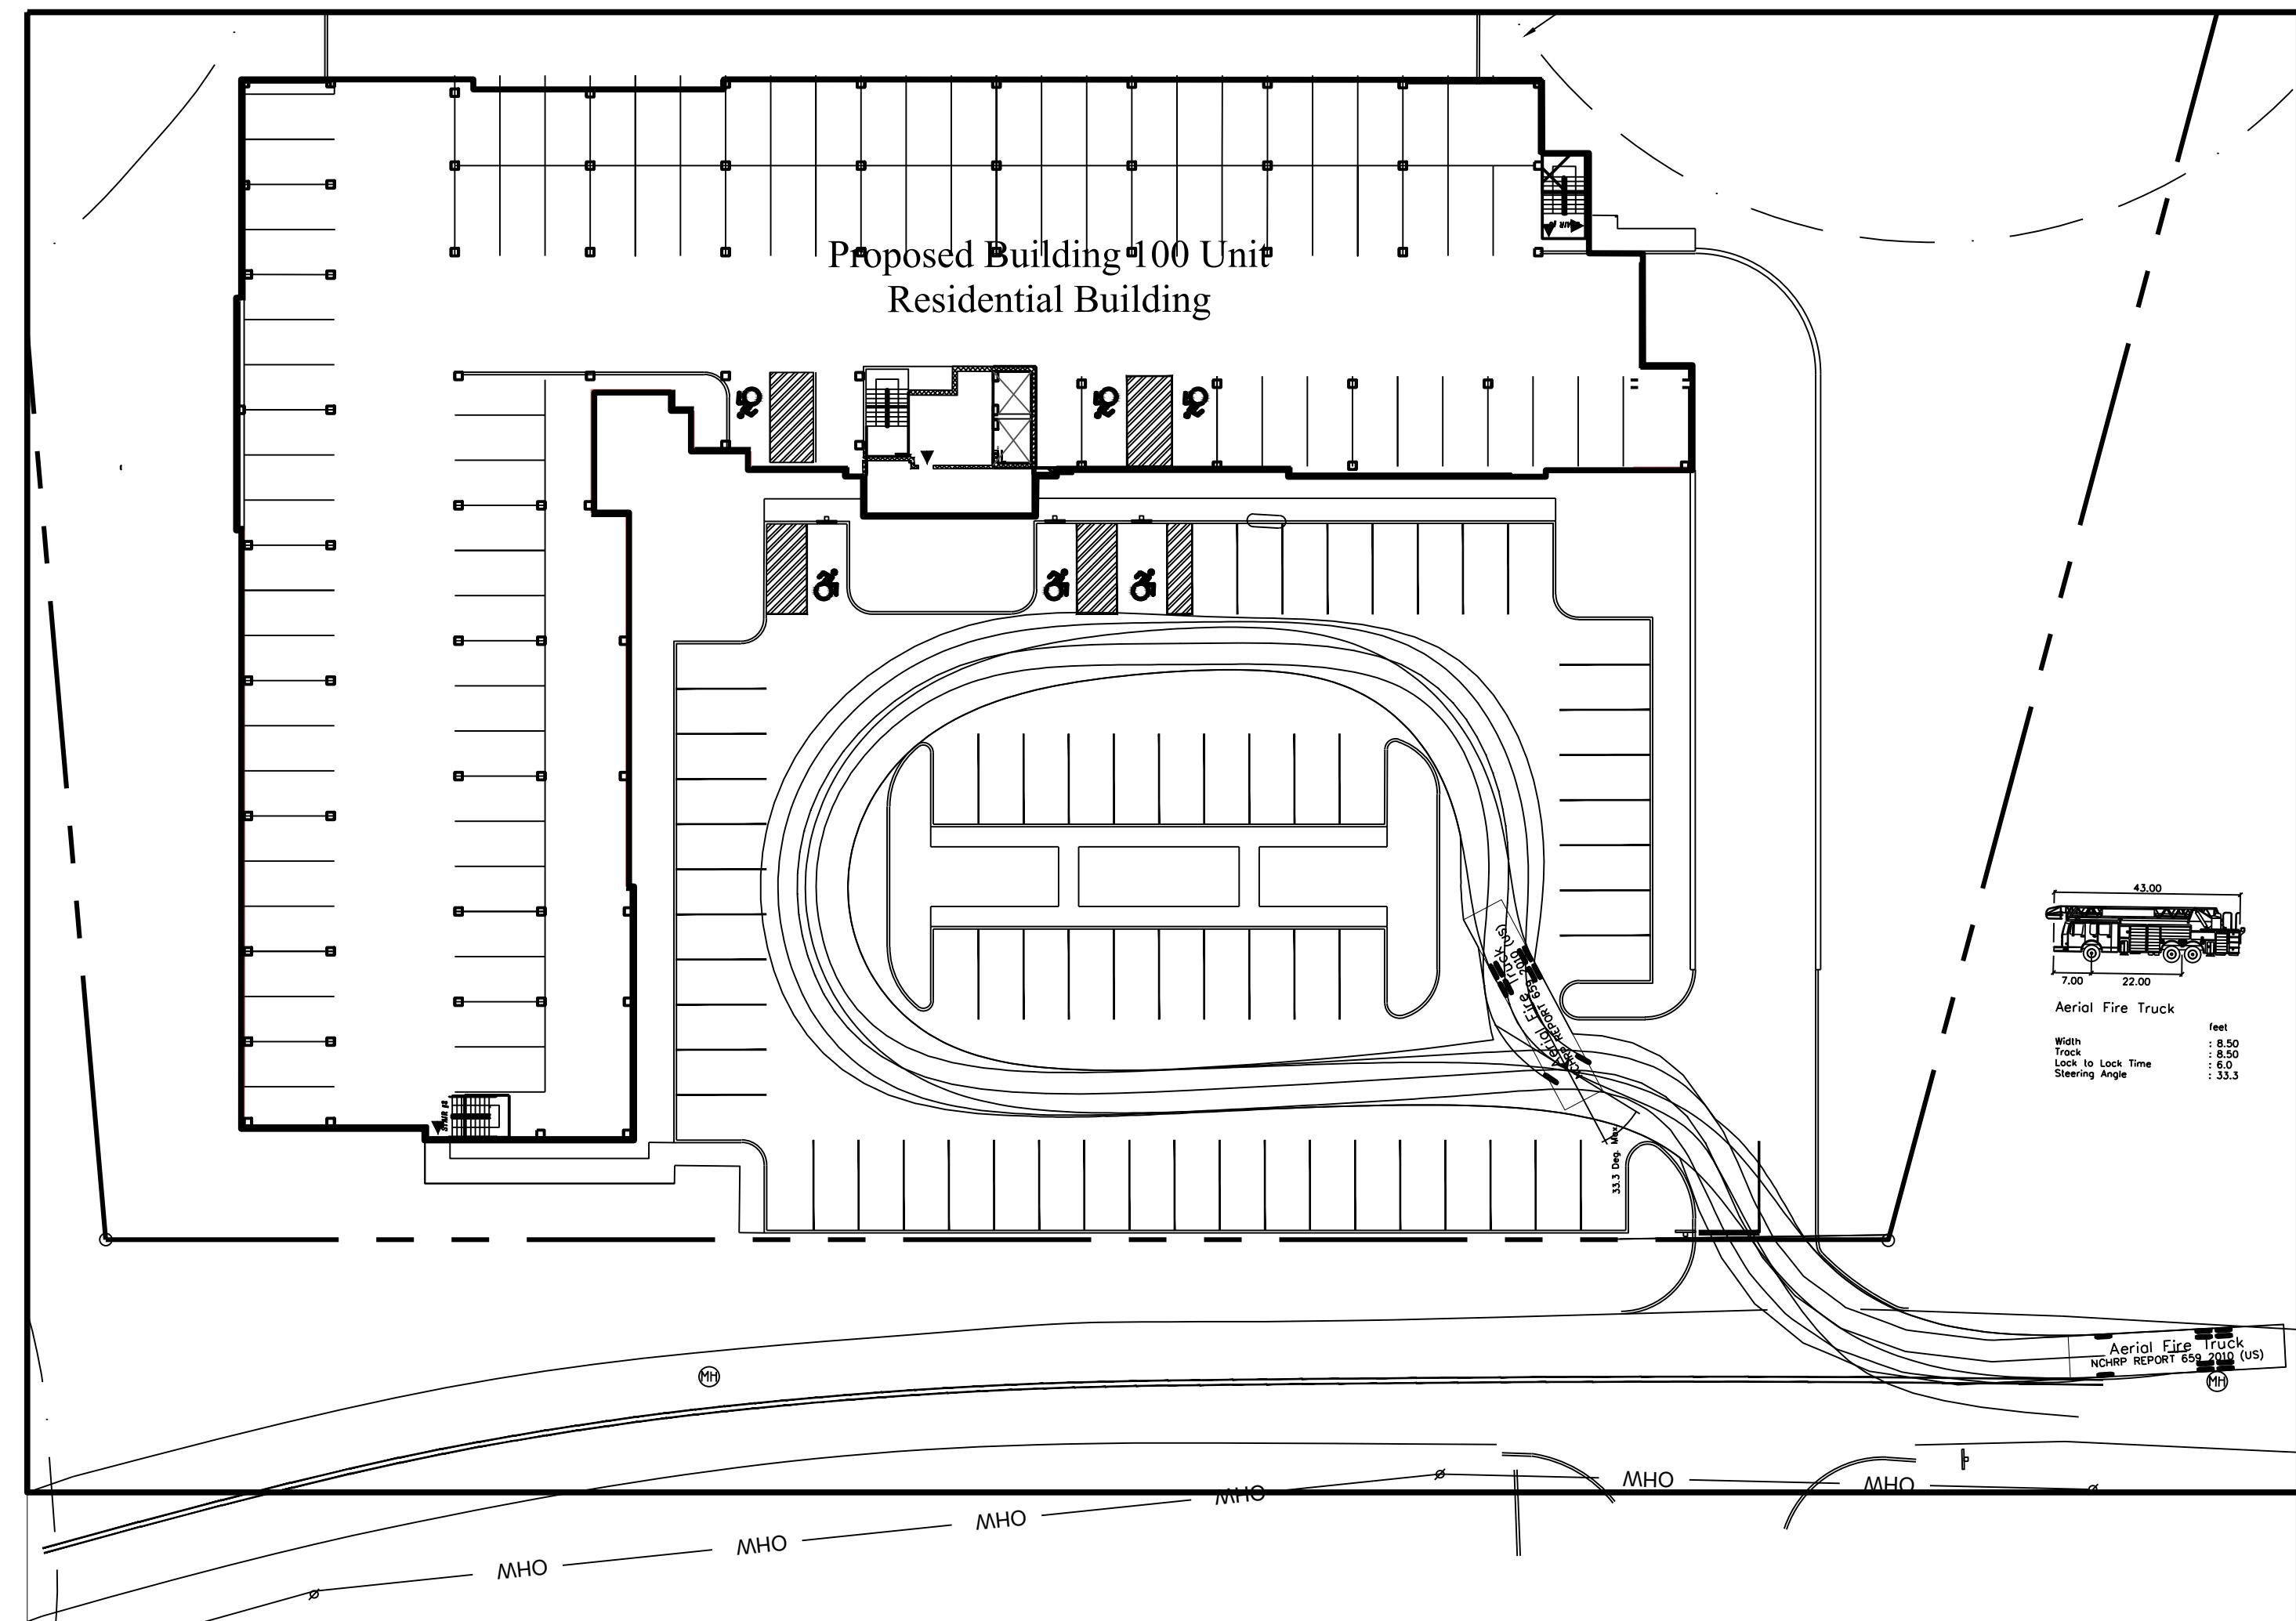


FIRE APPARATUS MOVEMENTS

SCALE: 1"=30'

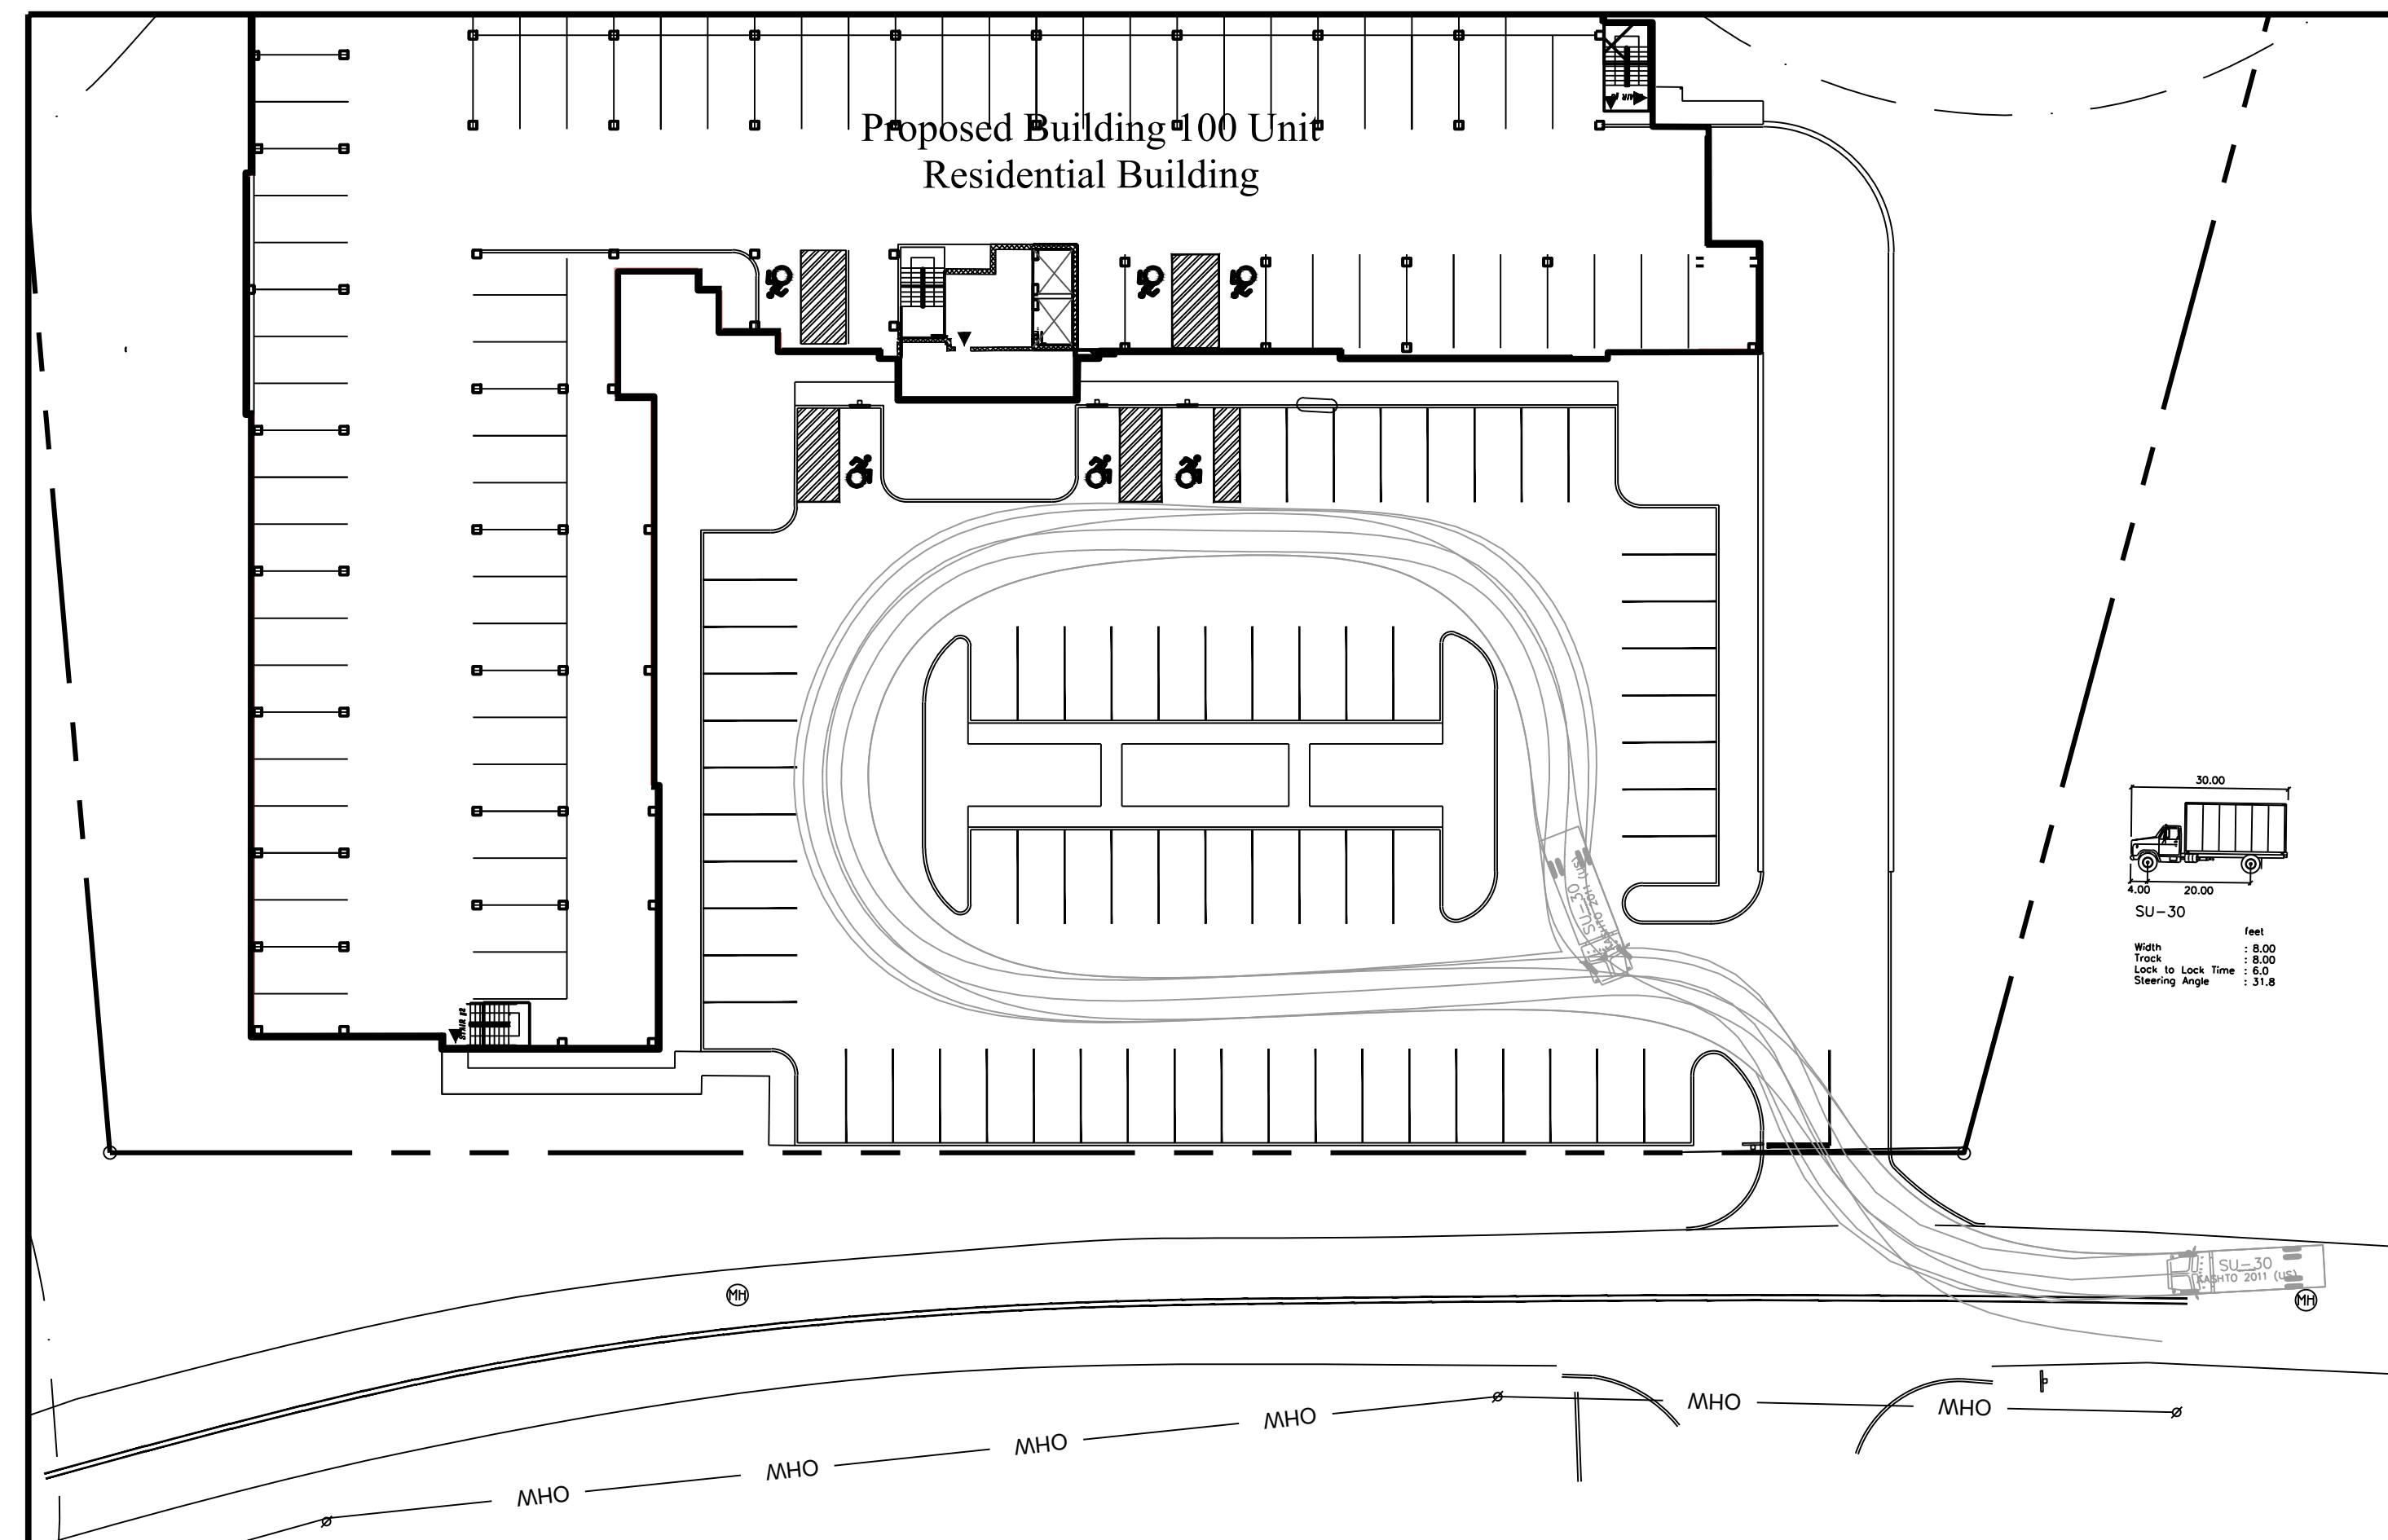


SU-30 MOVEMENTS

SCALE: 1"=30'

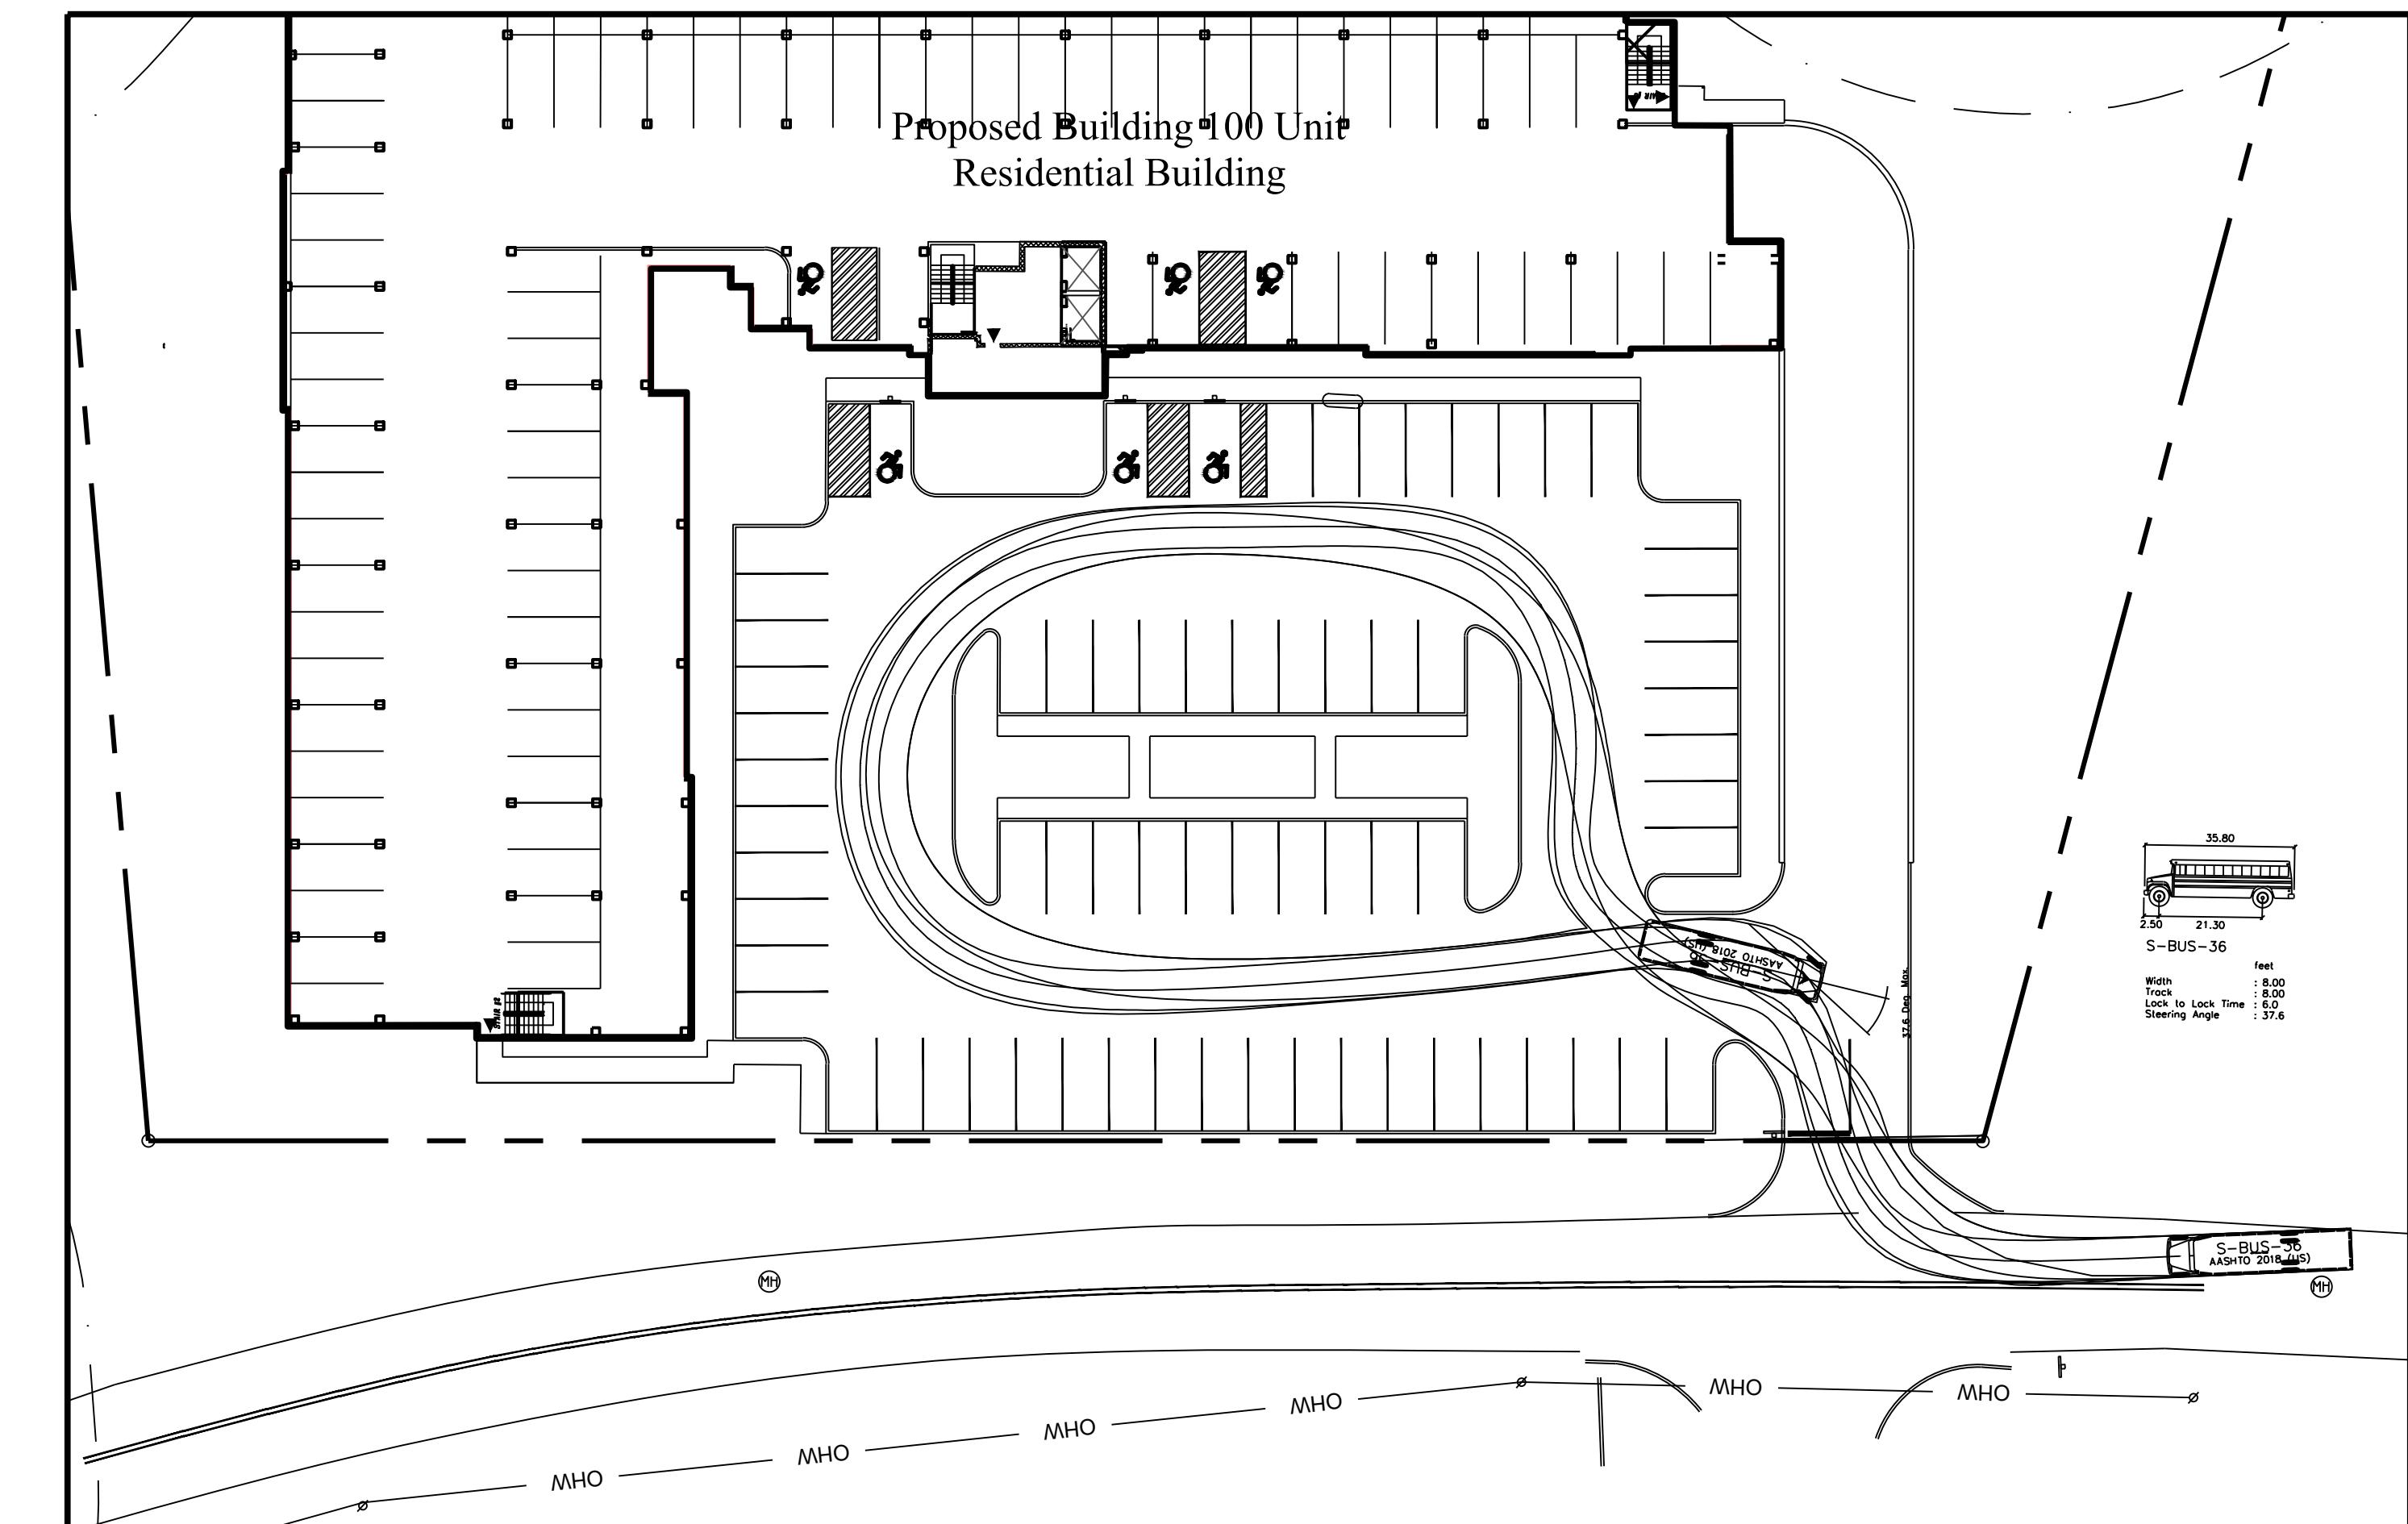


SCHOOL BUS MOVEMENTS

SCALE: 1"=30'

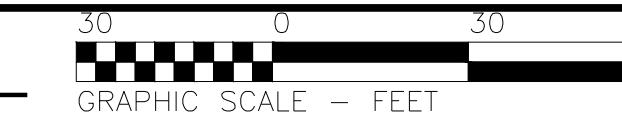

C-2.3

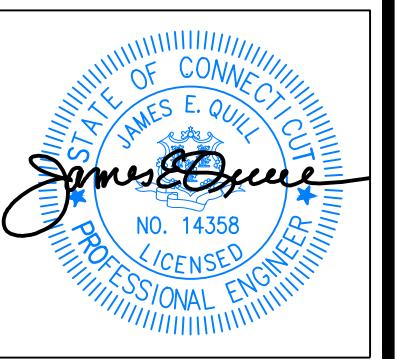

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PROPOSED 100-UNIT MULTIFAMILY DEVELOPMENT
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PREPARED FOR
BEECHER ROAD, LLC

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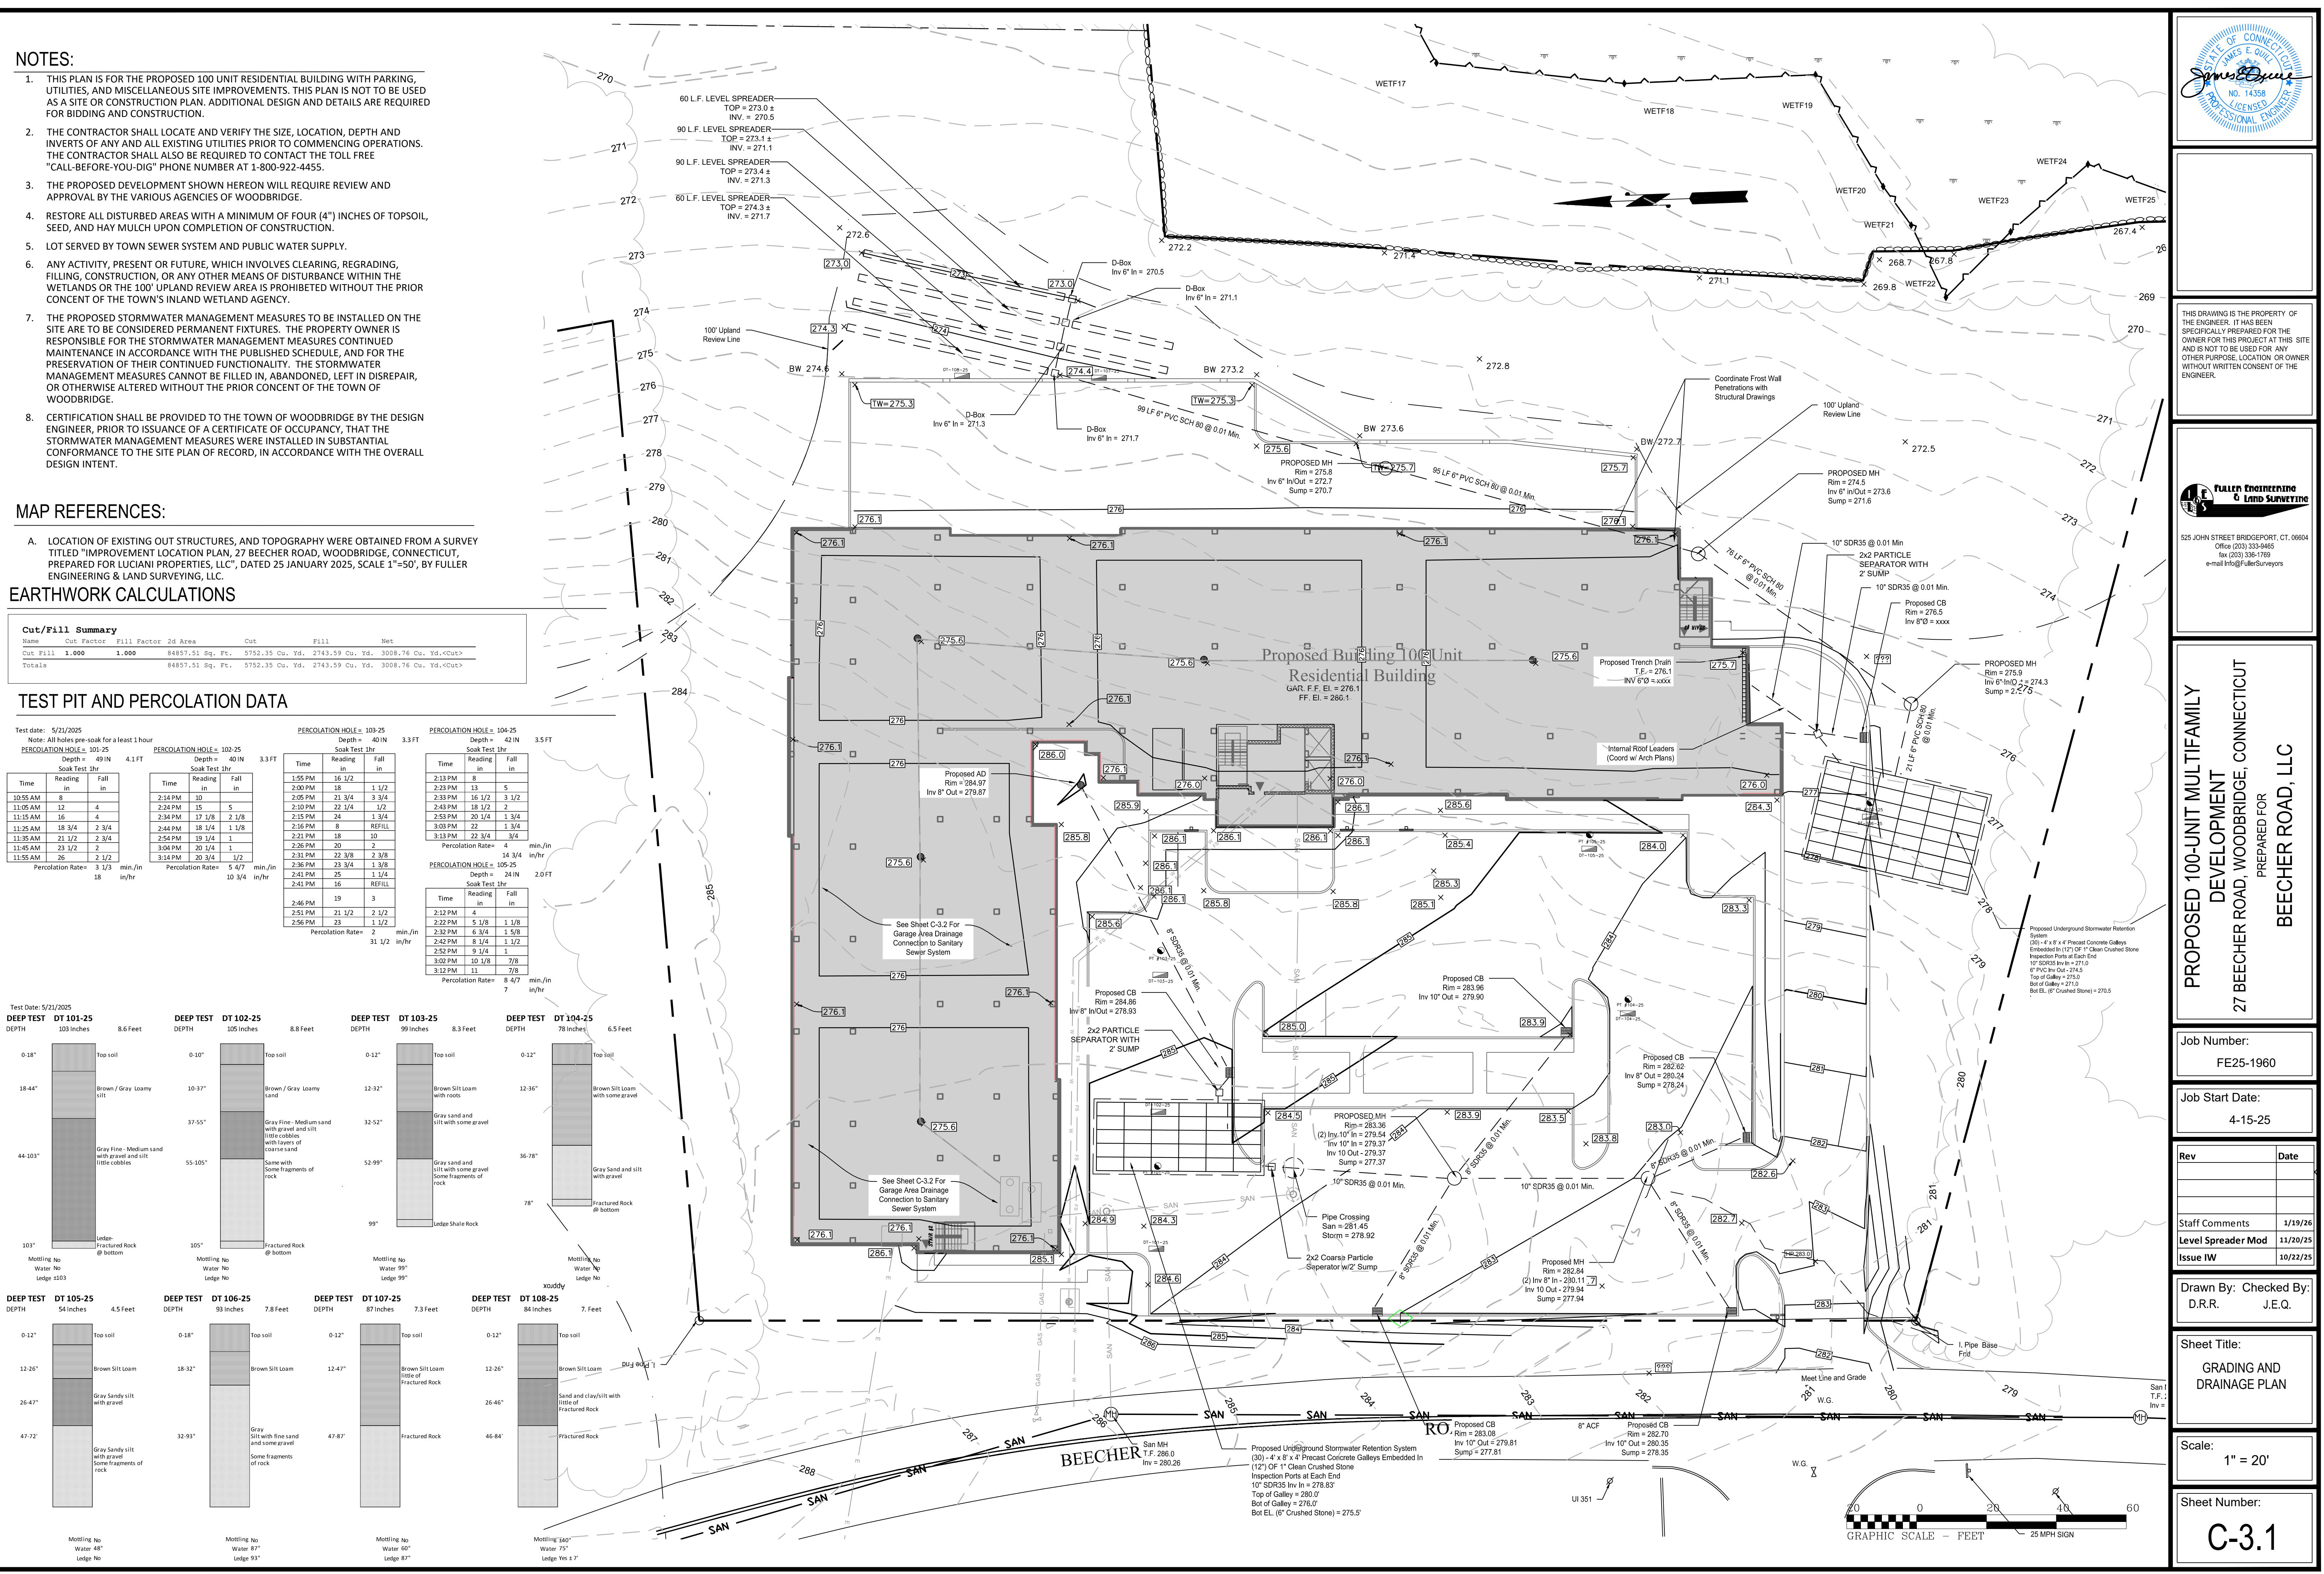
Staff Comments 1/19/26
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Issue IW 10/22/25

Drawn By: Checked By:
D.R.R. J.E.Q.

Sheet Title:
VEHICLE
MOVEMENT
ANALYSIS


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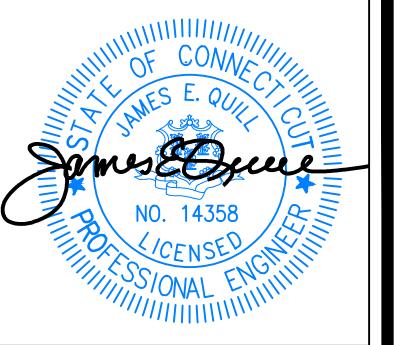
UTILITY NOTES:

1. THIS PLAN IS FOR PERMITTING PURPOSES ONLY AND SHOULD NOT BE USED FOR CONSTRUCTION.
2. THE CONTRACTOR SHALL FIELD VERIFY ALL EXISTING CONDITIONS, UTILITY LOCATIONS, AND INVERTS PRIOR TO CONSTRUCTION. ANY CONDITIONS FOUND TO DIFFER FROM THOSE SHOWN IN THE DRAWINGS SHALL BE IMMEDIATELY BROUGHT TO THE ATTENTION OF THE PROJECT ENGINEER.
3. THE CONTRACTOR SHALL BE RESPONSIBLE FOR NOTIFYING UTILITY COMPANIES 72 HOURS PRIOR TO BEGINNING EXCAVATION.
4. GENERAL CONTRACTOR SHALL BE RESPONSIBLE FOR ALL TAP AND TIE ON FEES REQUIRED, AS WELL AS COST OF UNDERGROUND SERVICE CONNECTIONS TO THE BUILDING.
5. ALL TRENCHING, PIPE LAYING, AND BACKFILLING SHALL BE IN ACCORDANCE WITH FEDERAL OSHA REGULATIONS & AWC.
6. CONTRACTOR TO COORDINATE GAS MAIN, WATER, ELECTRIC, AND TELEPHONE INSTALLATION WITH APPROPRIATE UTILITY COMPANIES.
7. CONTRACTOR SHALL MAINTAIN A MINIMUM OF 3 FEET OF COVER FOR ALL UNDERGROUND ELECTRIC, TELEPHONE AND GAS UTILITIES.
8. CONTRACTOR SHALL MAINTAIN A MINIMUM OF 4.5 FEET OF COVER FOR ALL WATER DISTRIBUTION PIPING.
9. ALL NEW WATER LINES SHALL BE PRESSURE TESTED AND LEAKAGE TESTED IN ACCORDANCE WITH THE LATEST EDITION OF AWWA STANDARD C600 BY AWC.
10. ALL NEW WATER MAINS SHALL BE DISINFECTED IN ACCORDANCE WITH AWWA STANDARD C651 BY AWC.
11. ALL FIRE HYDRANTS SHALL BE PROVIDED WITH AN APPROVED GATE VALVE AT A MAXIMUM OF 5'-0" FROM HYDRANT.
12. ALL PIPE LENGTHS ARE HORIZONTAL DISTANCES AND ARE APPROXIMATE.
13. ALL WORK SHALL COMPLY WITH ALL APPLICABLE CODES, REGULATIONS, AND/OR LOCAL STANDARDS IMPOSED BY LOCAL UTILITY AUTHORITIES.
14. ALL MATERIAL SHALL BE APPROVED BY THE LOCAL UTILITY COMPANIES UNLESS DIRECTED OTHERWISE BY THE ENGINEER.
15. INFORMATION ON EXISTING UTILITIES AND STORM DRAINAGE SYSTEMS HAS BEEN COMPILED FROM AVAILABLE INFORMATION INCLUDING UTILITY PROVIDER AND MUNICIPAL RECORD MAPS AND/OR FIELD SURVEY AND IS NOT GUARANTEED CORRECT OR COMPLETE. UTILITIES AND STORM DRAINAGE SYSTEMS ARE SHOWN TO ALERT THE CONTRACTOR TO THEIR PRESENCE AND THE CONTRACTOR IS SOLELY RESPONSIBLE FOR DETERMINING ACTUAL LOCATIONS AND ELEVATIONS OF ALL UTILITIES AND STORM DRAINAGE SYSTEMS INCLUDING SERVICES. PRIOR TO DEMOLITION OR CONSTRUCTION, THE CONTRACTOR SHALL CONTACT "CALL YOU BEFORE YOU DIG" 72 HOURS BEFORE COMMENCEMENT OF WORK AND VERIFY ALL UTILITY AND STORM DRAINAGE SYSTEM LOCATIONS.
16. THRUST BLOCKS SHALL BE PROVIDED AT ALL TEES, ELBOWS, BENDS AND PLUGS OF SUFFICIENT SIZE TO COMPLY WITH MINIMUM STANDARDS OF N.F.P.A - EXISTING SOIL CONDITIONS.
6. ANY ACTIVITY, PRESENT OR FUTURE, WHICH INVOLVES CLEARING, REGRADING, FILLING, CONSTRUCTION, OR ANY OTHER MEANS OF DISTURBANCE WITHIN THE WETLANDS OR THE 100' UPLAND REVIEW AREA IS PROHIBITED WITHOUT THE PRIOR CONCERN OF THE TOWN'S INLAND WETLAND AGENCY



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6. EROSION CONTROL MEASURES SHOWN ARE SUGGESTED LOCATIONS. ACTUAL PLACEMENT OF PROPOSED EROSION CONTROL MEASURES TO BE DETERMINED IN THE FIELD IN CONSULTATION WITH THE DESIGN ENGINEER PRIOR TO COMMENCEMENT OF CONSTRUCTION.
7. ALL WORK PERFORMED BY THE OWNER / DEVELOPER MUST INCLUDE IMPLEMENTATION OF AN APPROVED SOIL EROSION AND SEDIMENTATION PLAN IN ACCORDANCE WITH PUBLIC ACT NO. 83-388 [PASSED BY THE CONNECTICUT GENERAL ASSEMBLY]. THE OWNER / DEVELOPER SHALL BE THOROUGHLY FAMILIAR WITH THE CONNECTICUT GUIDELINES FOR EROSION AND SEDIMENT CONTROL.
8. SEE SHEET C-4.2 FOR DETAILED SOIL EROSION AND SEDIMENT CONTROL NOTES AND DETAILS.
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10. SILT FENCE EQUALS LIMITS OF DISTURBANCE. SILT FENCE SHALL BE LOCATED IN FIELD BY A LICENSED LAND SURVEYOR PRIOR TO THE START OF CONSTRUCTION. CERTIFICATION SHALL BE PROVIDED TO THE TOWN OF PLAN COMPLIANCE WITH THE CLEARING LIMITS AND WITH THE EROSION AND SEDIMENTATION CONTROL MEASURES DESCRIBED HEREON.

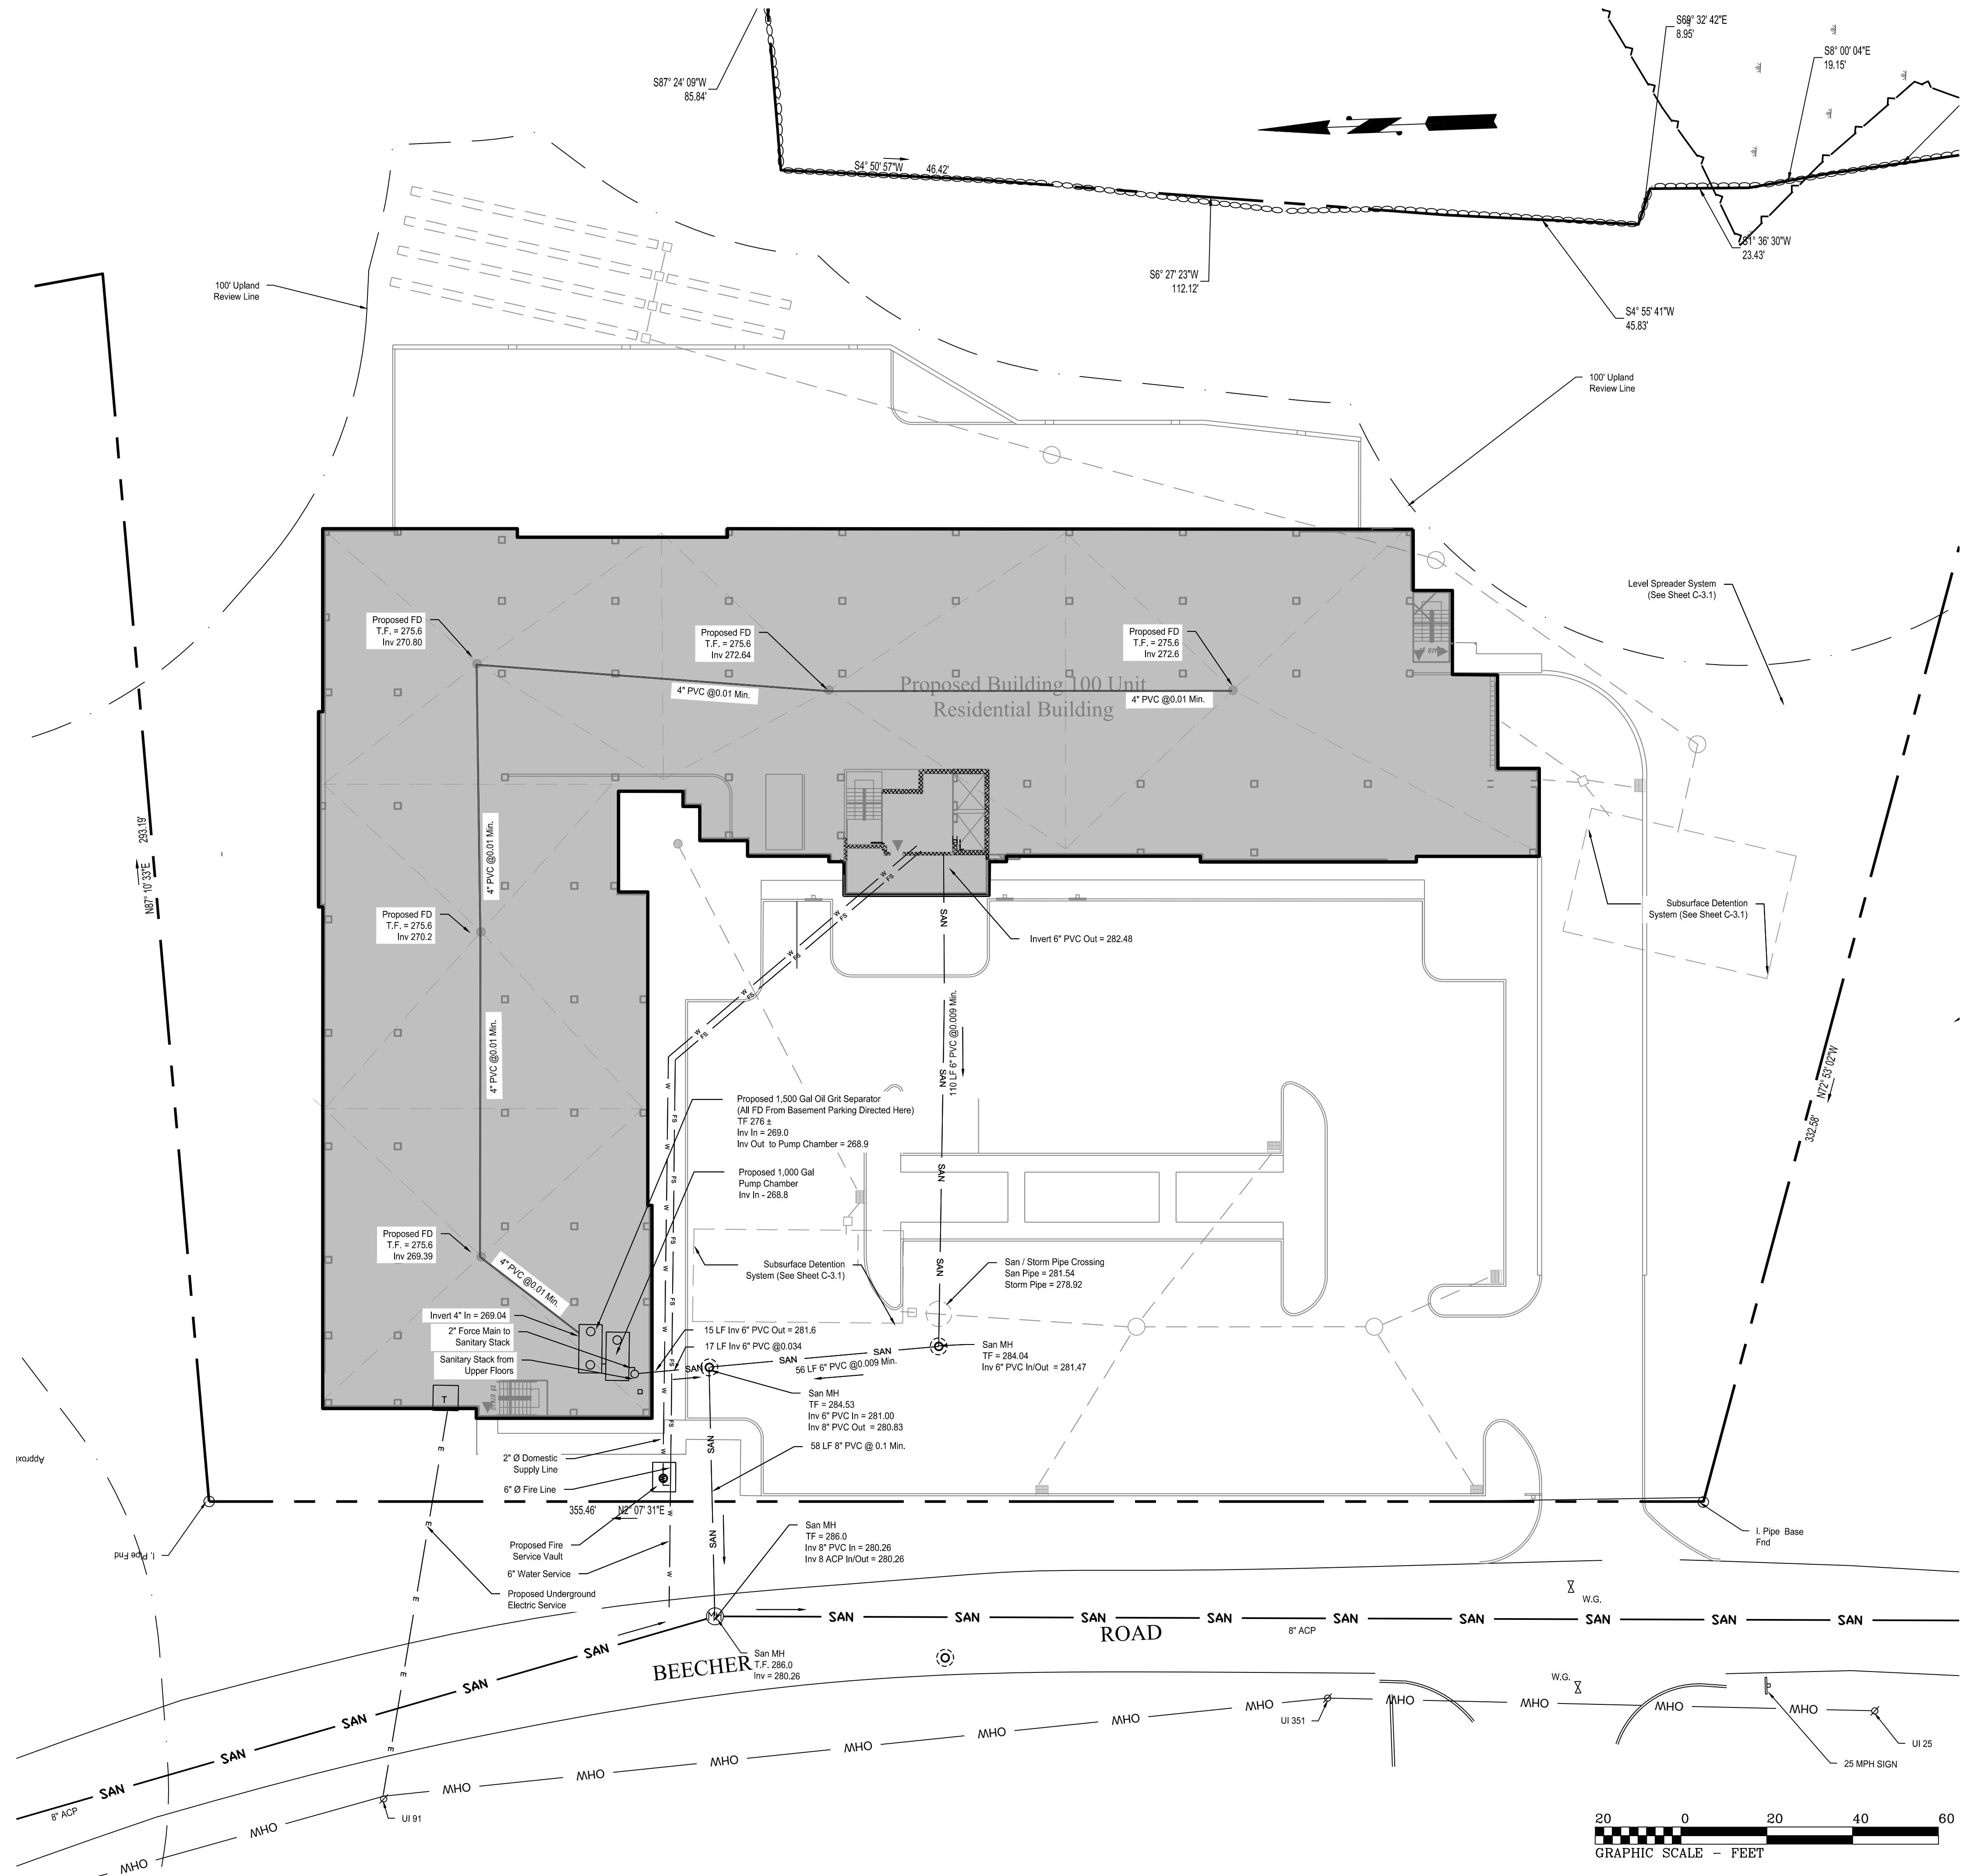

MAP REFERENCES:


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SEDIMENT BASIN CALCULATIONS

SEDIMENT TRAP	CONTRIBUTING AREA	CY Required	CF Required
1	.6 AC	76 CY	2,045 CF
2	1.7 AC	227 CY	6,135 CF
TOTAL	2.3 AC	303 CY	8,181 CF

TOTAL SEDIMENT TRAP STORAGE CAPACITY **8,390 CF**

NOTE
TEMPORARY SEDIMENT TRAPS HAVE BEEN SIZED TO PROVIDE A MINIMUM STORAGE VOLUME OF 134 CUBIC YARDS PER ACRE OF DRAINAGE ARE PER THE 2002 CONNECTICUT GUIDELINES FOR SOIL EROSION AND SEDIMENT CONTROL

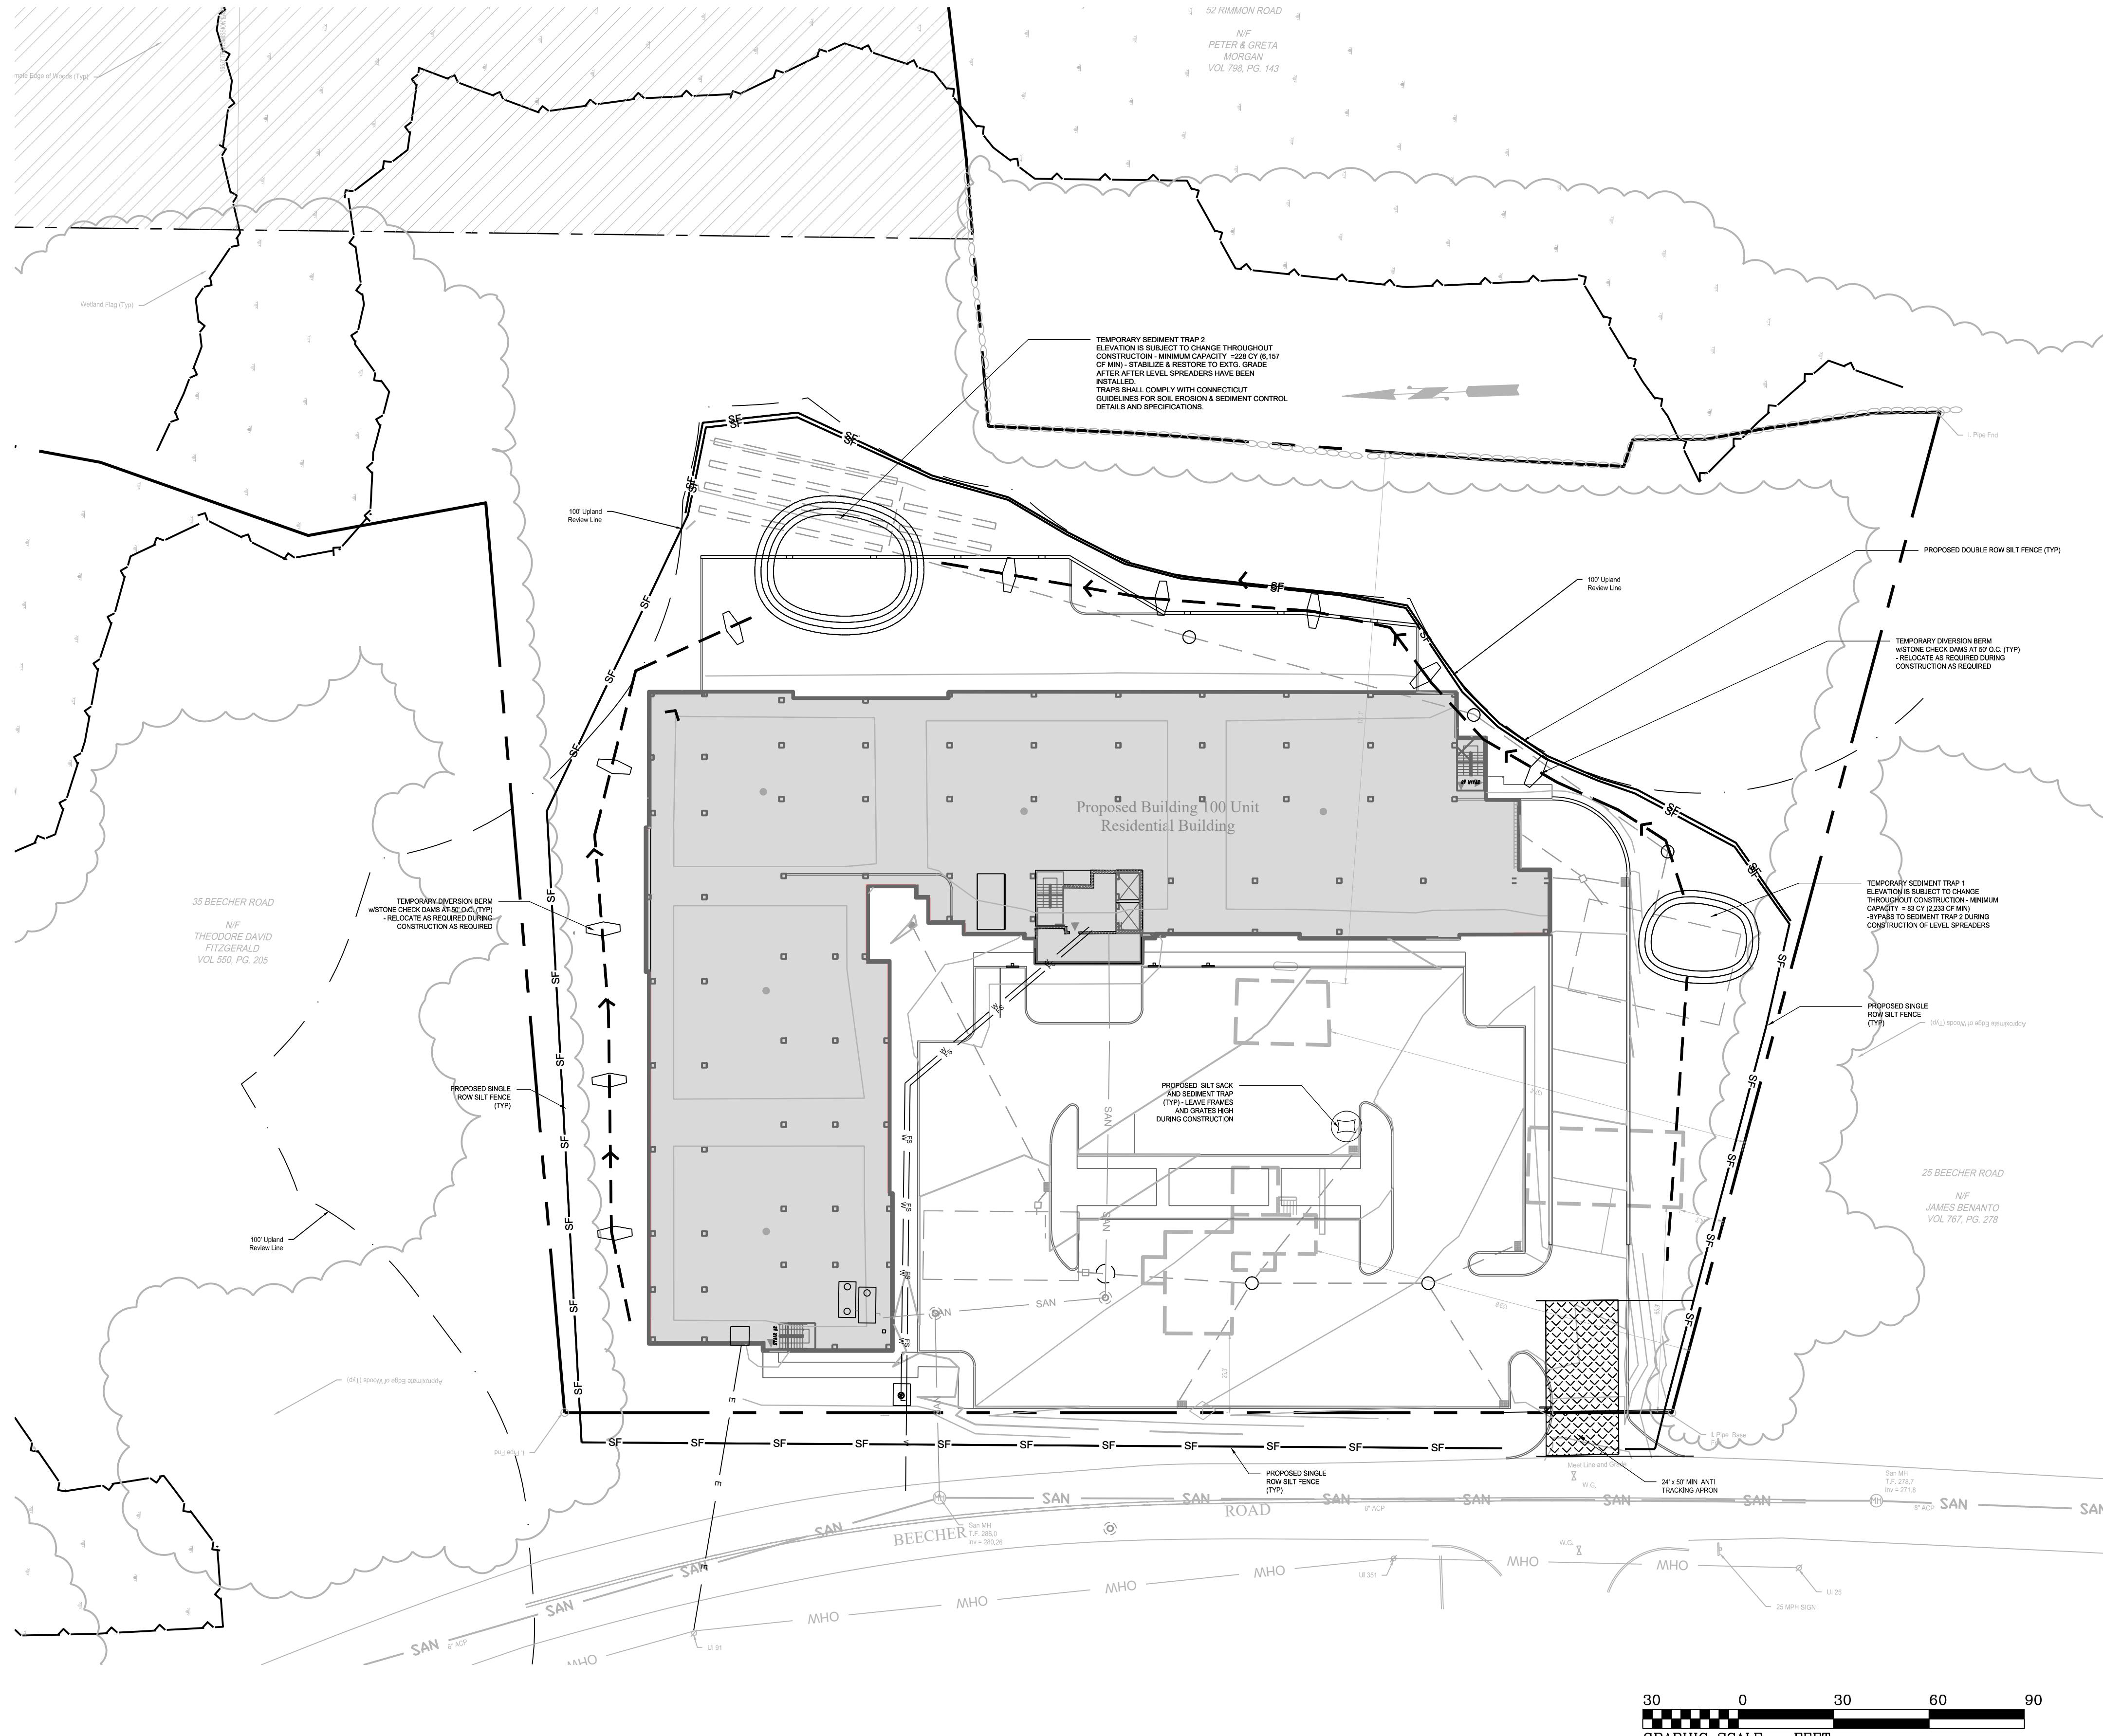

PROPOSED 100-UNIT MULTIFAMILY DEVELOPMENT
27 BEECHER ROAD, WOODBRIDGE, CONNECTICUT
PREPARED FOR
BEECHER ROAD, LLC

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Job Start Date:
4-15-25



Rev Date
Staff Comments 1/19/26
Level Spreader Mod 11/20/25
Issue IW 10/22/25

Drawn By: Checked By:
D.R.R. J.E.Q.
Sheet Title:
EROSION & SEDIMENT CONTROL PLAN

Scale:
1" = 30'

Sheet Number:
C-4.1


Oil Separators

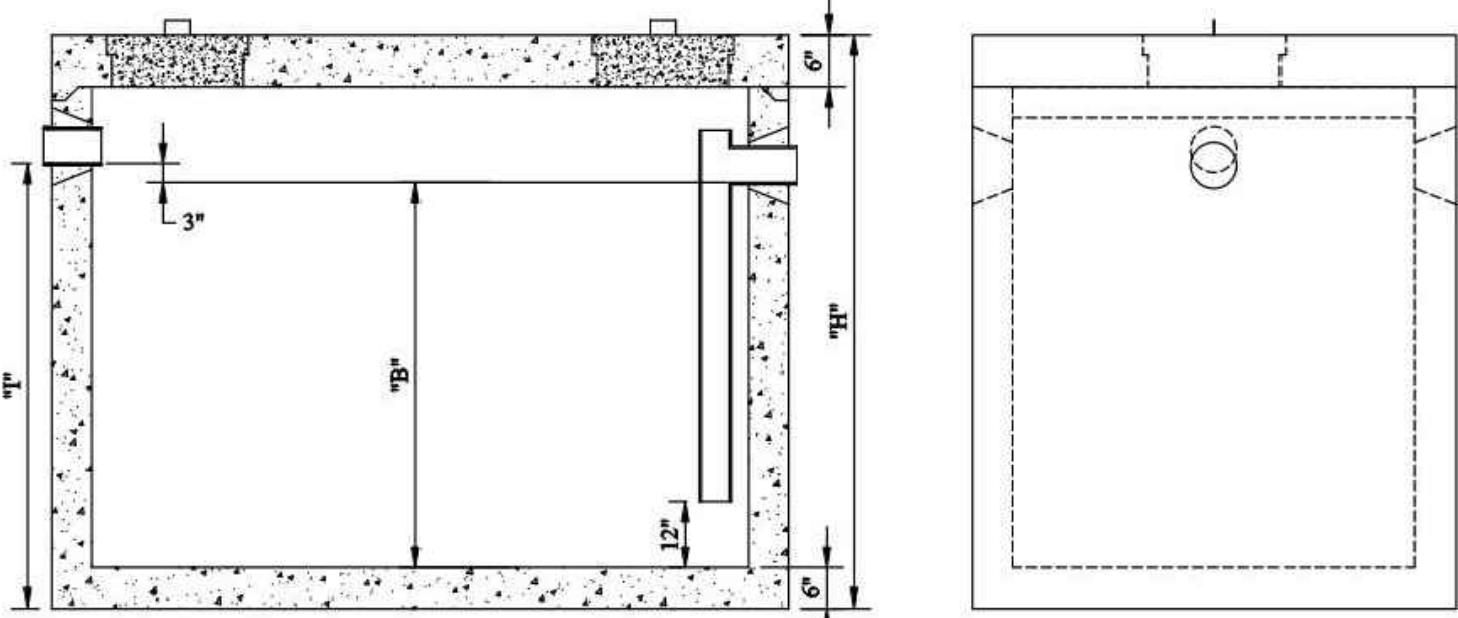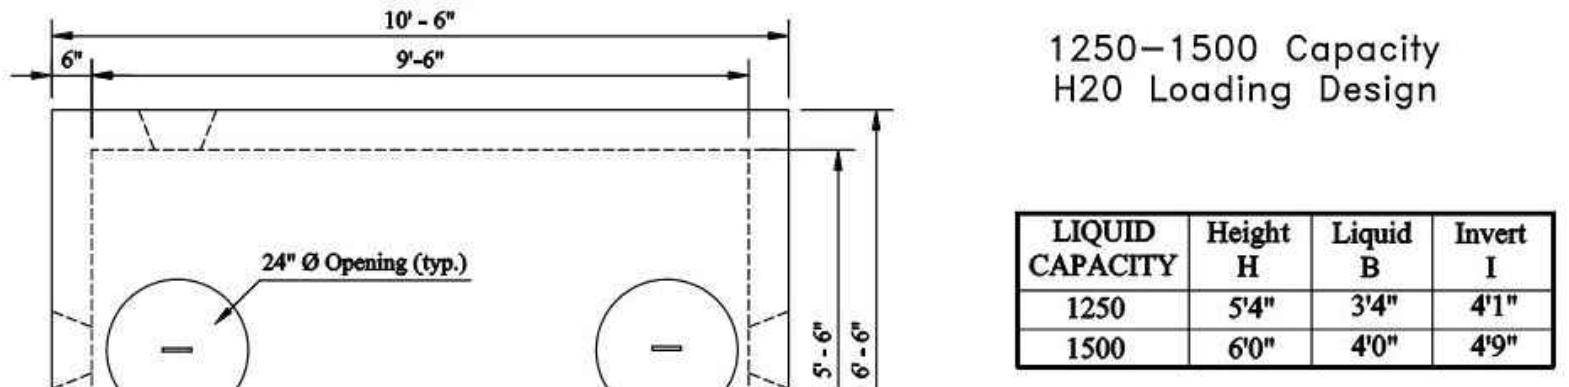

1. Minimum Concrete Compressive Strength: 4000 psi @ 28 days
2. Design Loading: AASHTO HS-20
3. Top Slab: 6" Thick Asphalt Coated Exterior
4. Monolithic Base & Walls
5. Top Slab Joint Sealed With Butyl Rubber
6. Connecticut DOT & DEP Approved
7. Interior Piping Supplied & Installed By Others

p. fenninger 12.17.07

TYP OIL Grit SEPARATOR

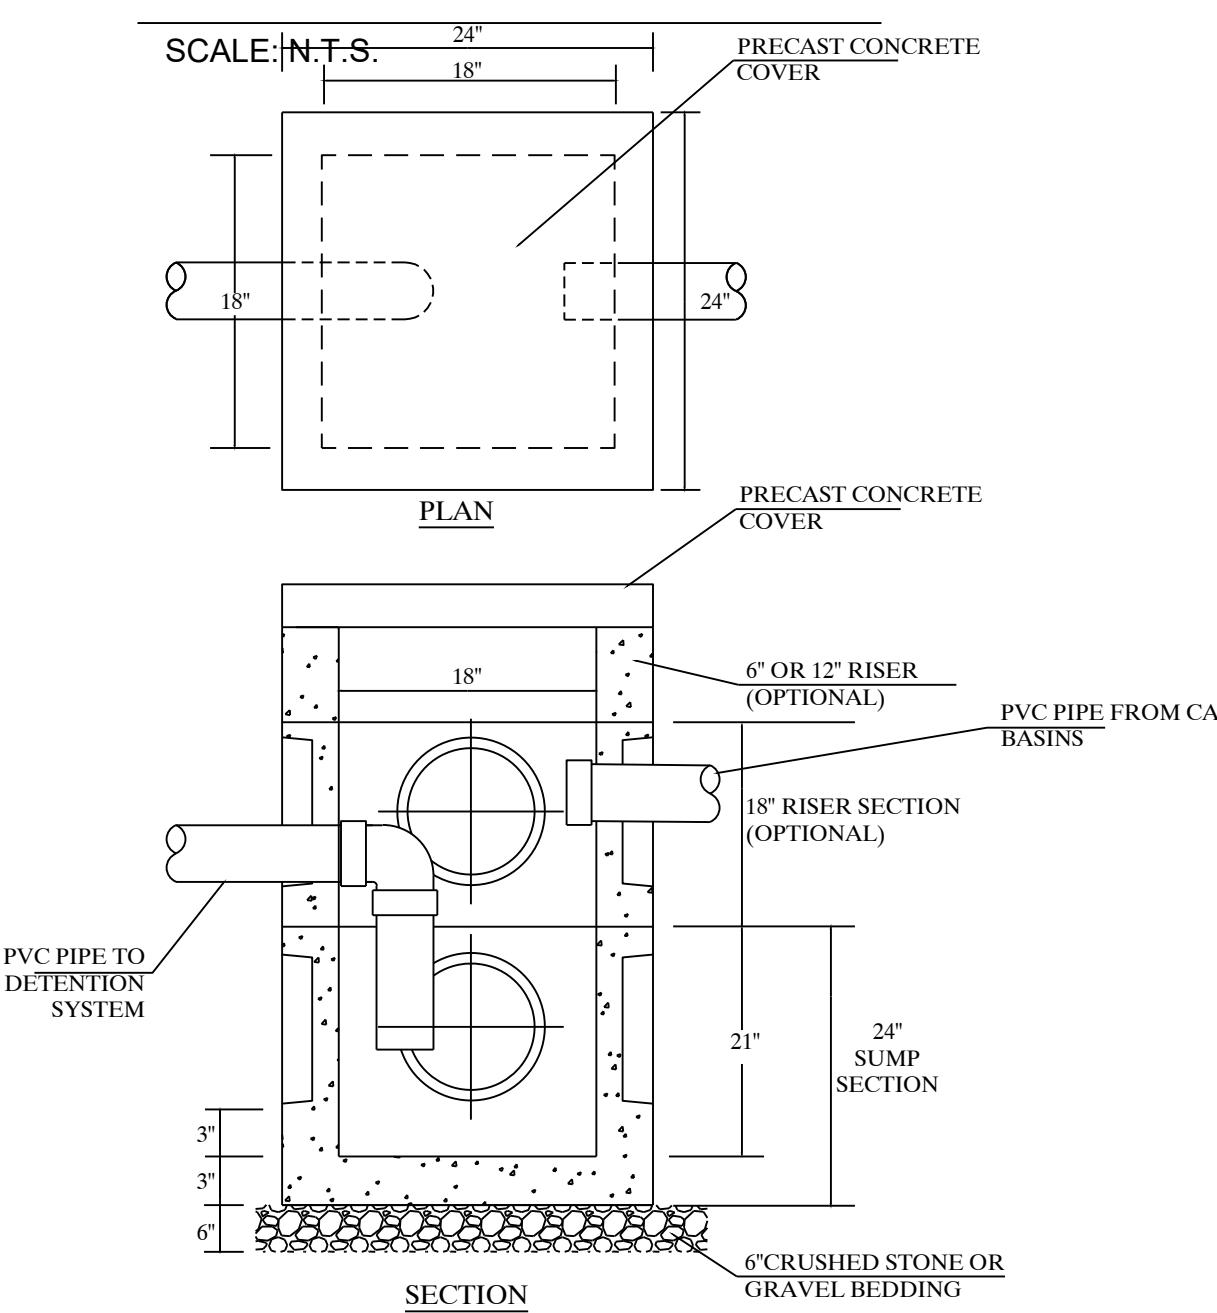


COARSE PARTICLE SEPARATOR

SCALE: N.T.S.


PRECAST CONCRETE DISTRIBUTION BOX

NOT TO SCALE

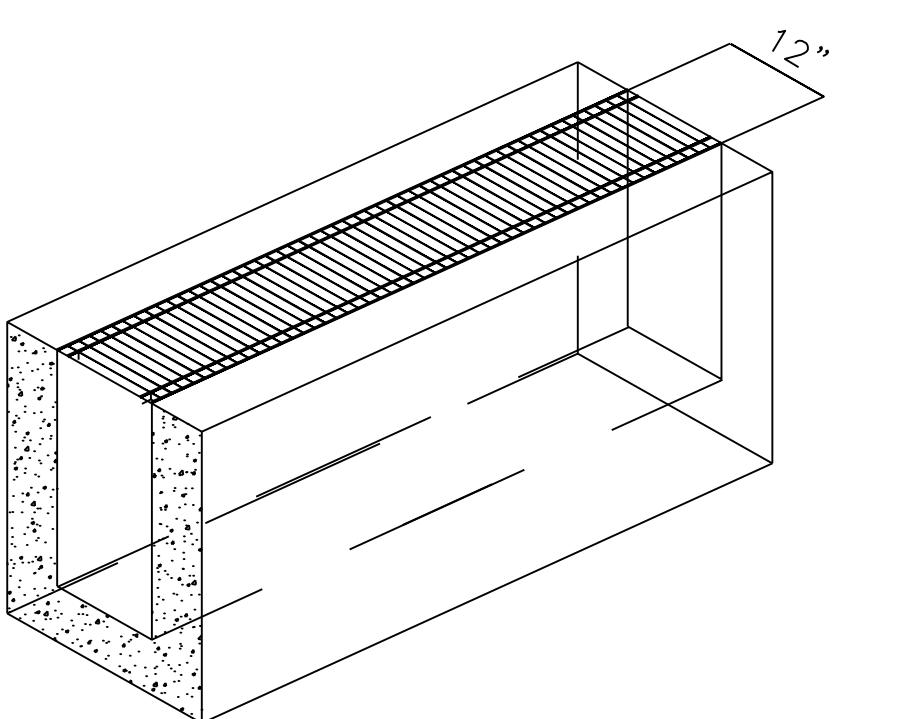


TYP TRENCH DRAIN DETAIL

SCALE: N.T.S.

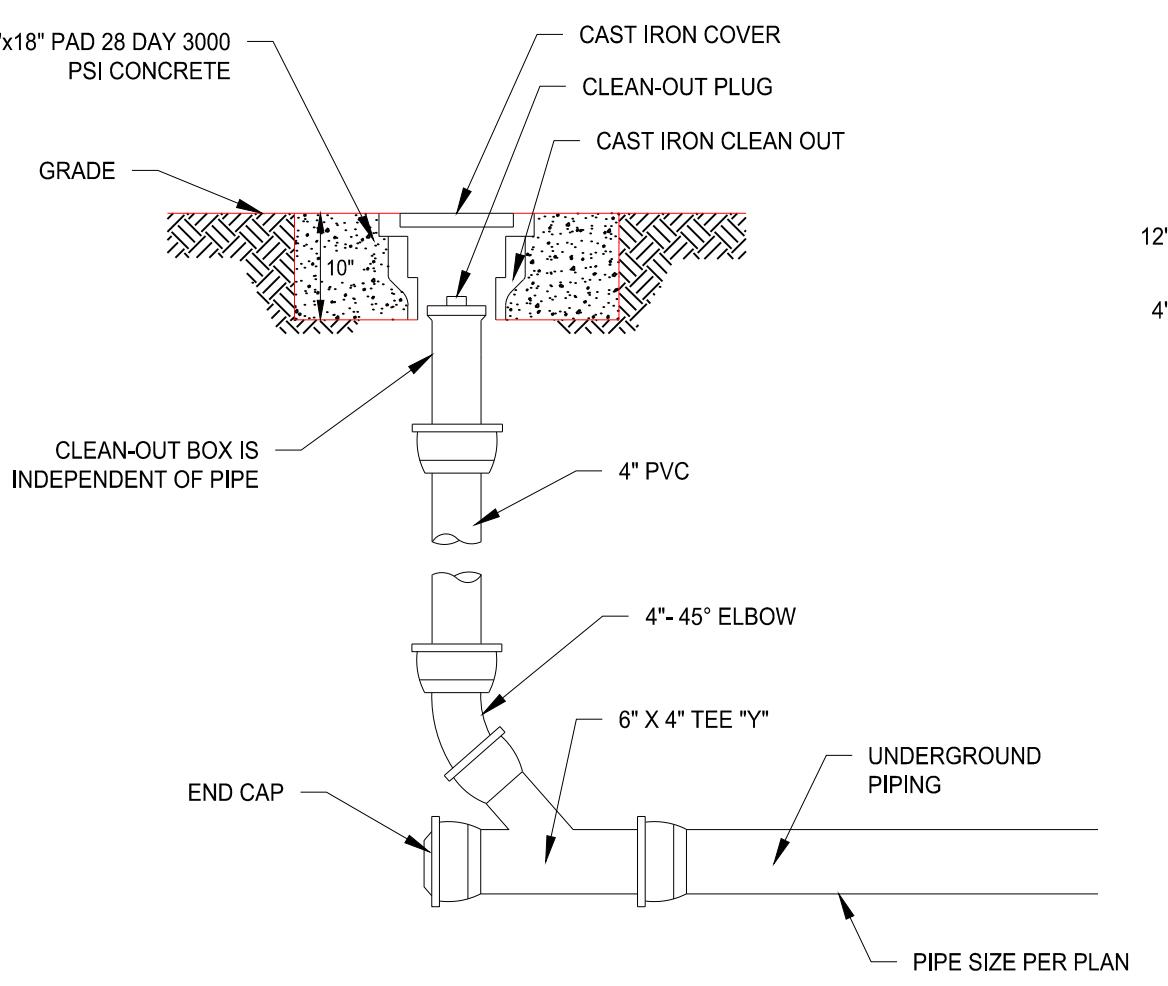

STORM CLEANOUT DETAIL

PIPE SIZE PER PLAN

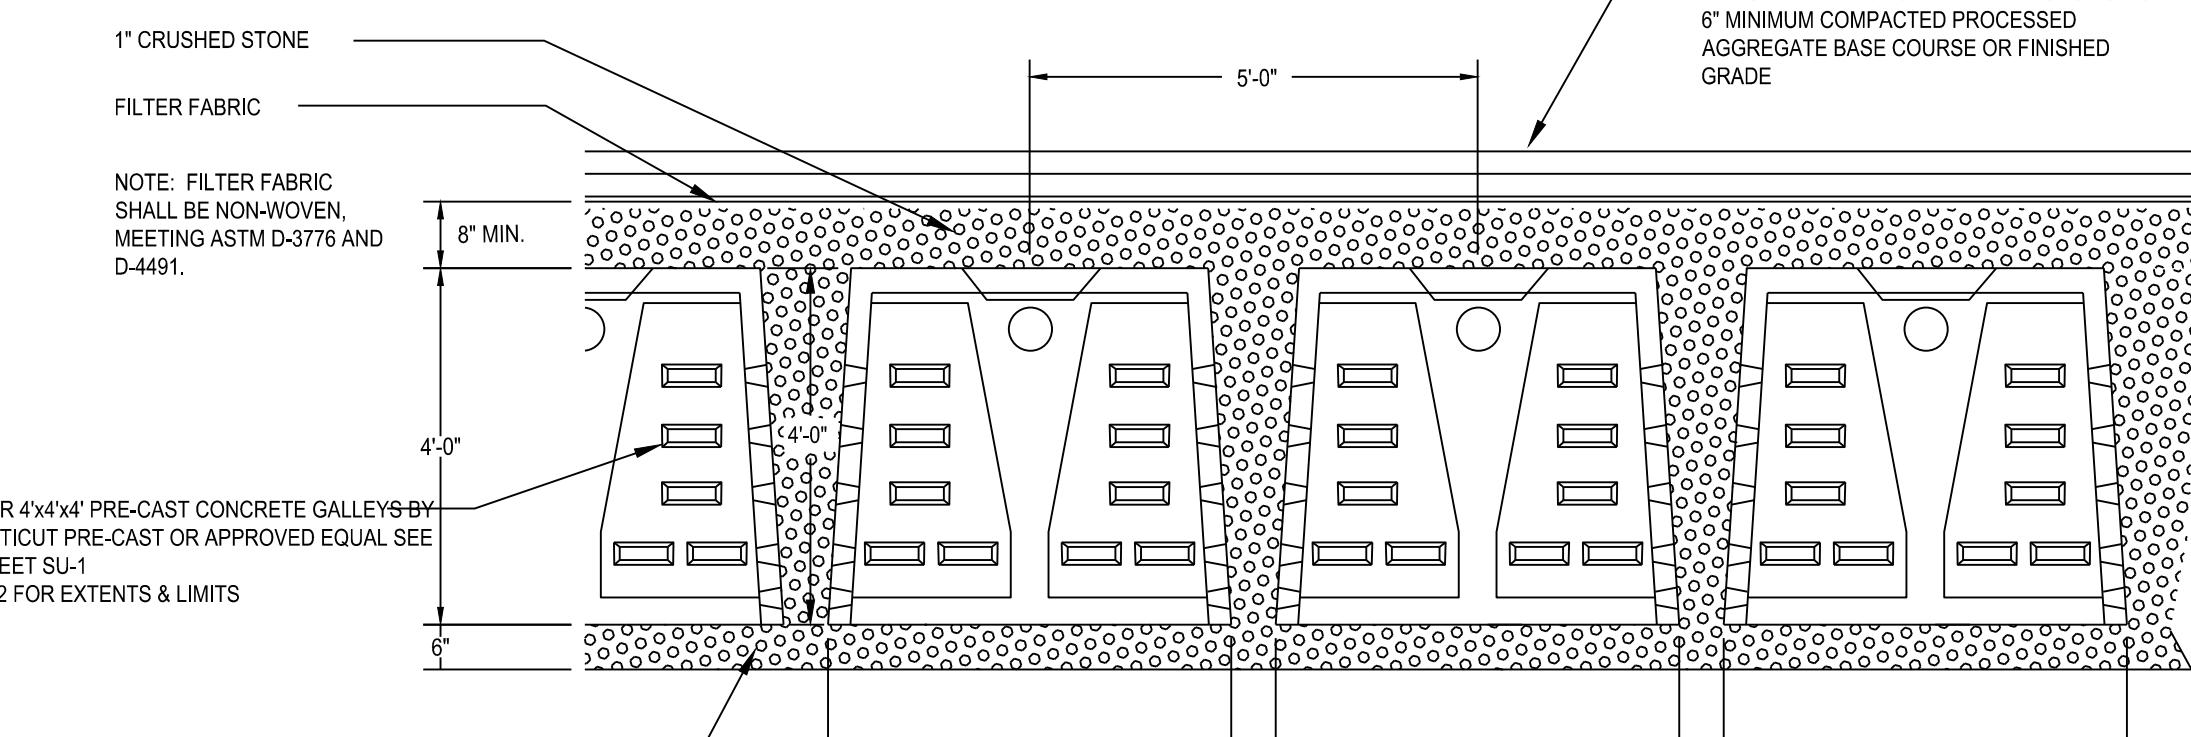


SUBSURFACE STORM WATER RETENTION
4'x4' PRE-CAST LEACHING GALLERY FIELD DETAIL

NOT TO SCALE


TYP CONCRETE GALLERY DETAIL

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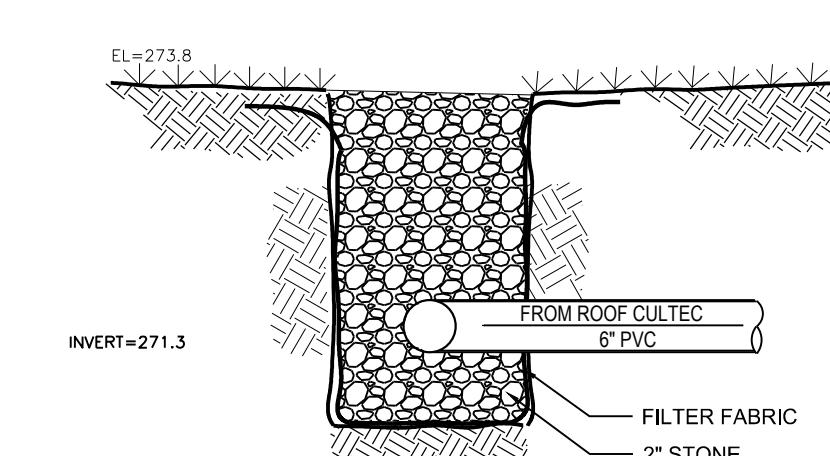
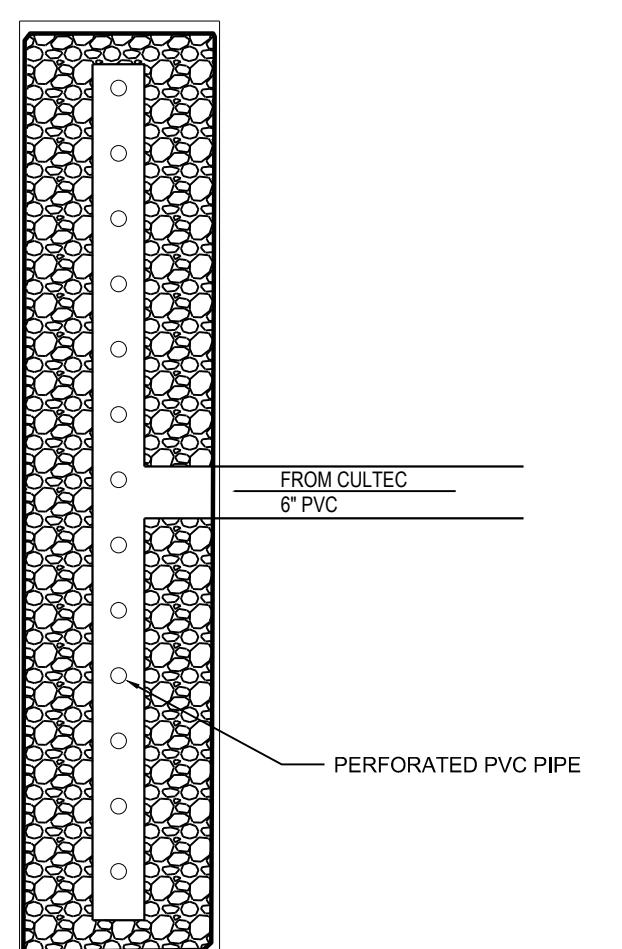
PRECAST STORM MANHOLE / CATCHBASIN

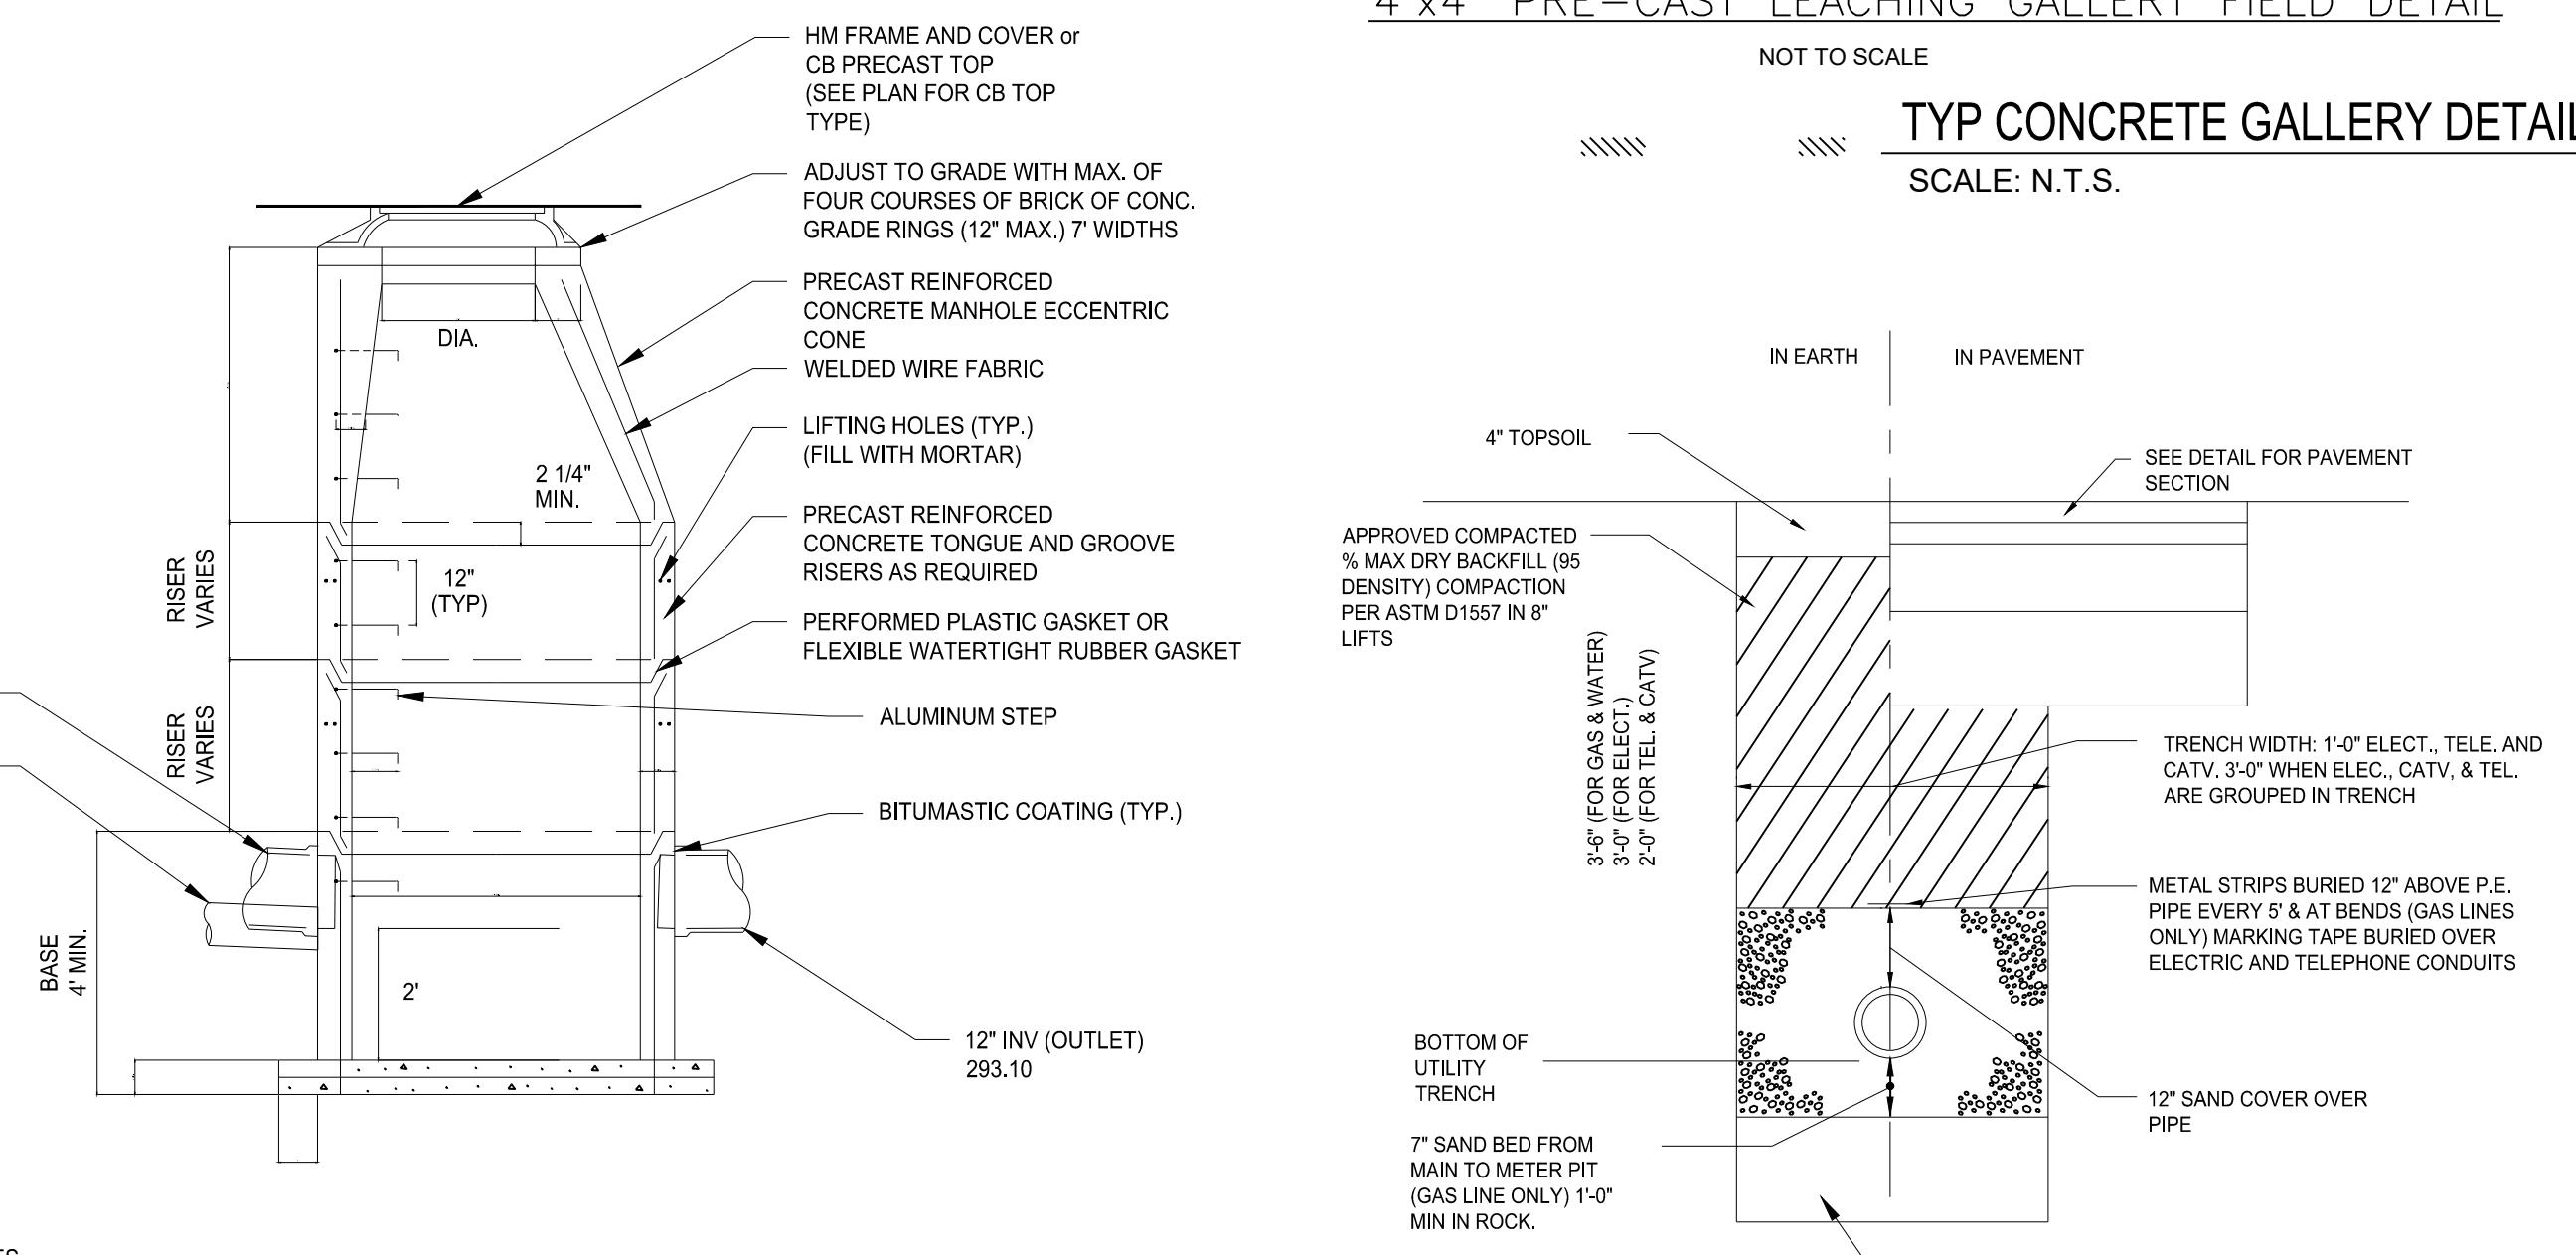SCALE: N.T.S.




TYPICAL UTILITY TRENCH DETAIL

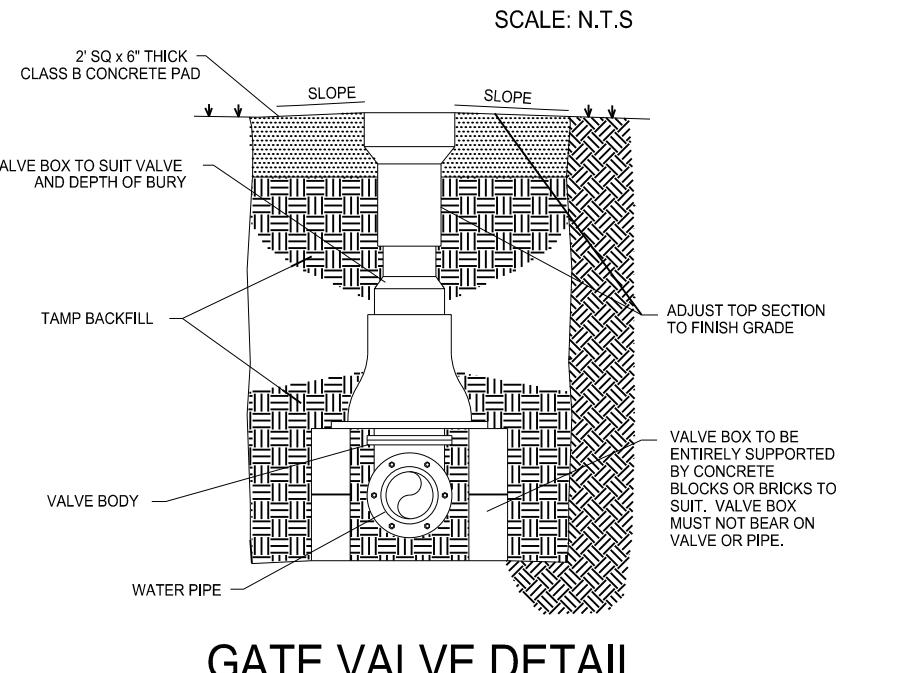SCALE: N.T.S.



LEVEL SPREADER DETAIL

SCALE: N.T.S.

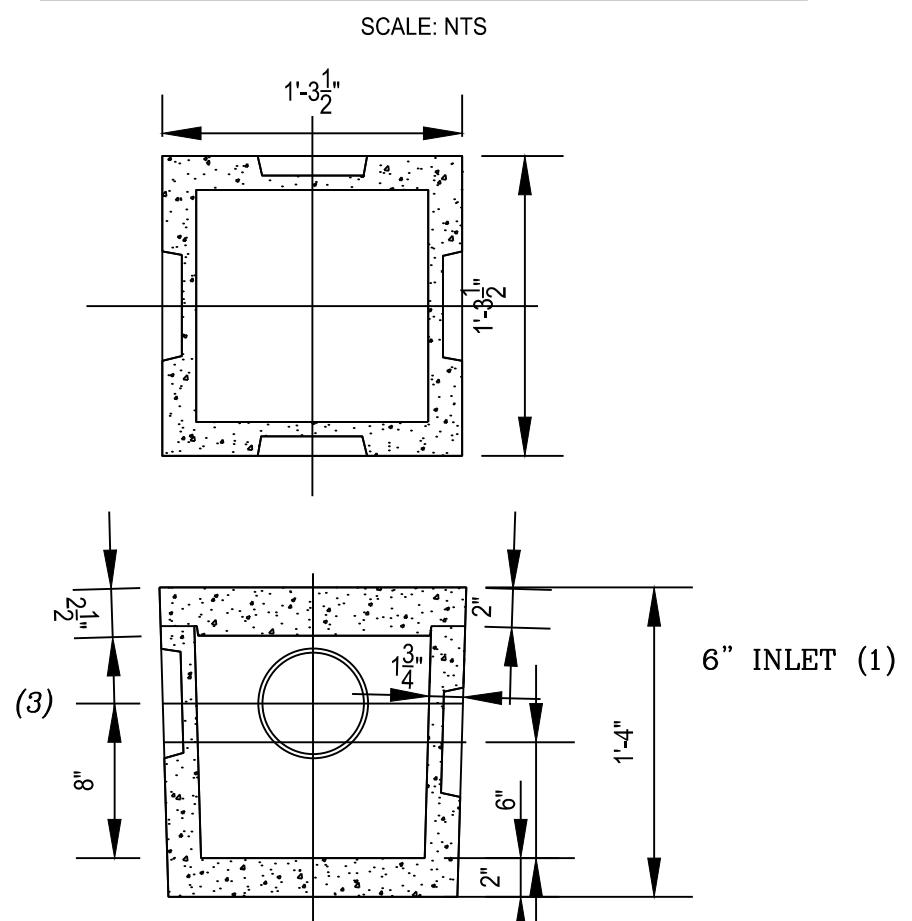


PRECAST CONCRETE DISTRIBUTION BOX

NOT TO SCALE


TYP PUMP CHAMBER DETAIL

SCALE: N.T.S.

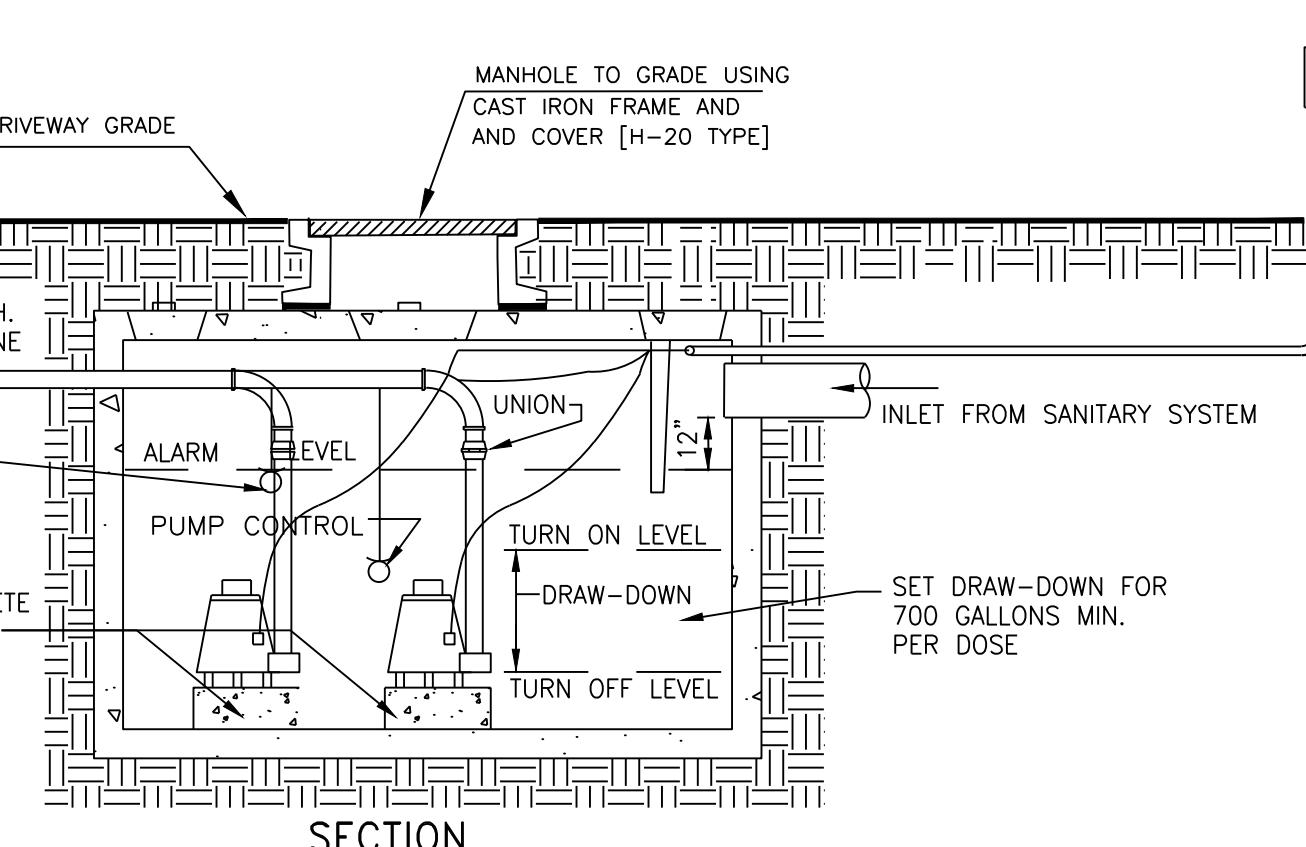

PUMP NOTES:

- 1 PUMP TO BE FLYGT 5.9 HP, MODEL NO. 2630 3PH
- 2 HIGH LEVEL ALARM TO WARNING LIGHT AND BUZZER TO WARN OF PUMP FAILURE
- 3 FORCE MAIN TO HAVE A MINIMUM OF 3' COVER
- 4 PUMP TO BE CONFIGURED TO RUN ALTERNATELY OR TOGETHER

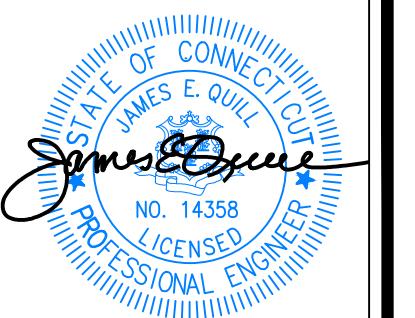

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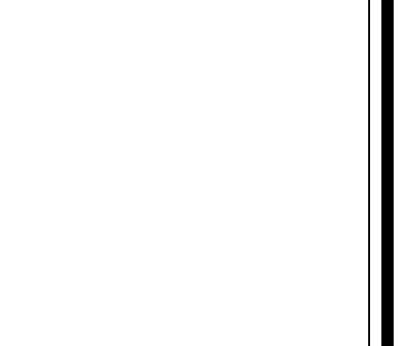
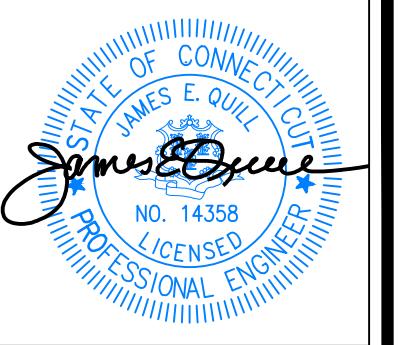
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Sheet Title:
DETAIL SHEET

Scale:

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PREPARED FOR BEECHER ROAD, LLC

Job Number: FE25-1960


Job Start Date: 4-15-25

Rev	Date
ISSUED	XXX
Staff Comments	1/19/26
Level Spreader Mod	11/22/25
Issue IW	10/22/25

Drawn By: Checked By:
D.R.R. J.E.Q.


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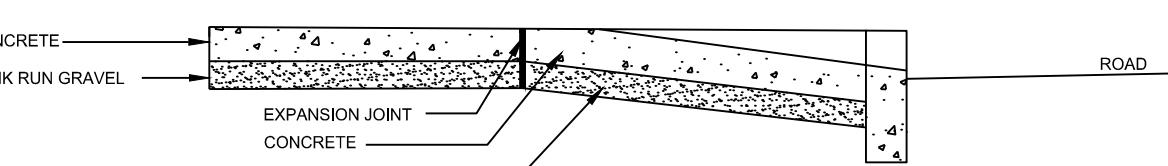


CONCRETE SIDEWALK

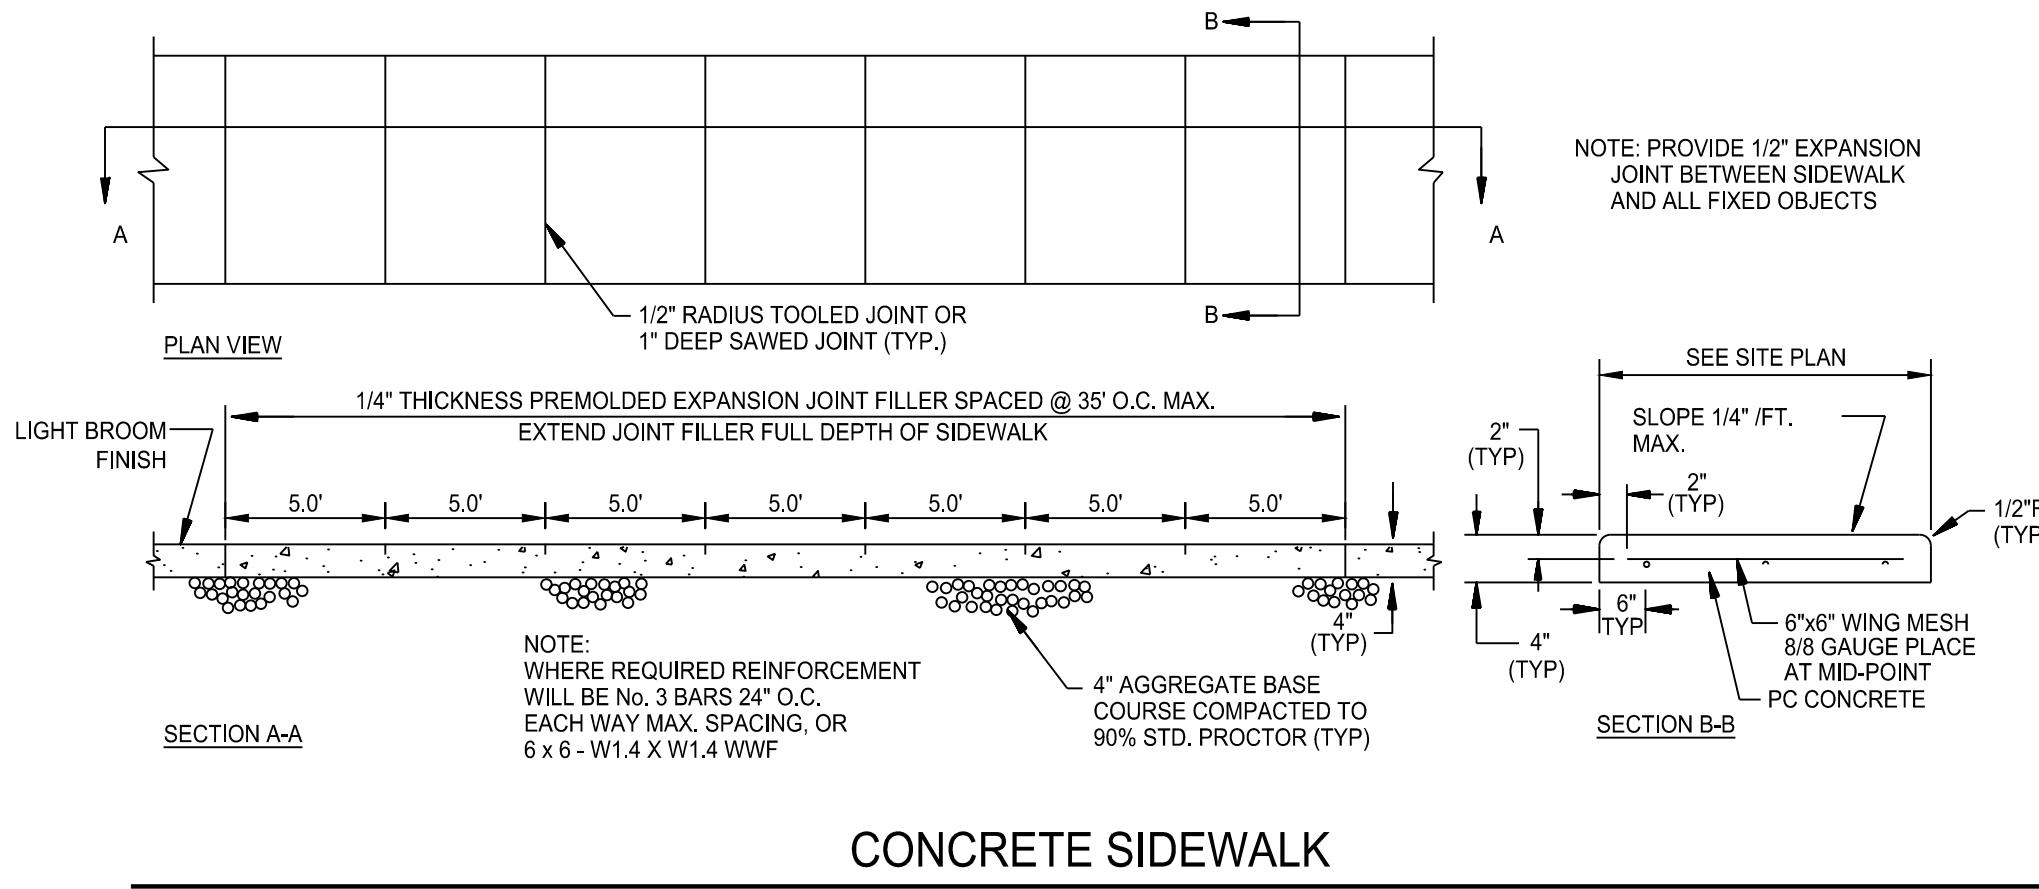SCALE: NTS




NOTE:
SIDEWALK SHALL BE 6" THICK AT ALL DRIVEWAYS

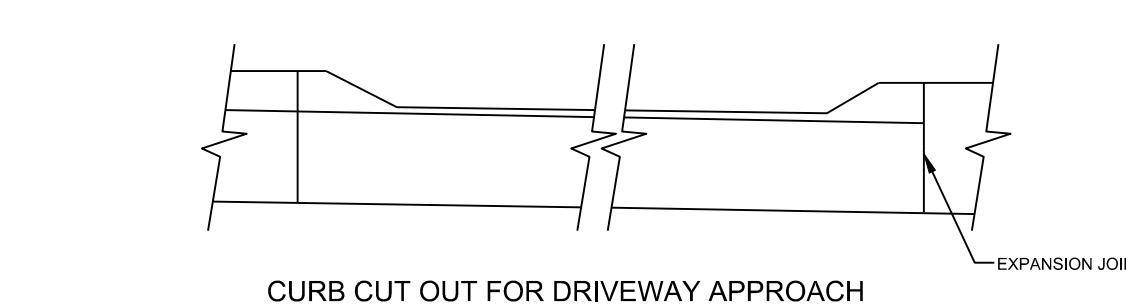


SECTION OF CONCRETE DRIVEWAY APPROACH

SCALE: NTS

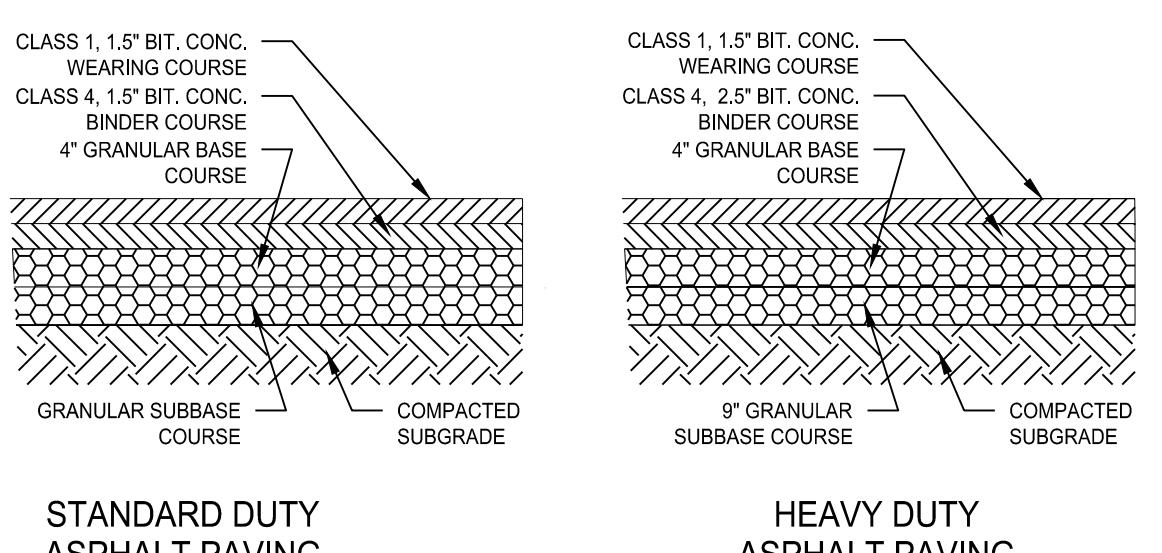


PAVING DETAILS


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CONTRACTION JOINT

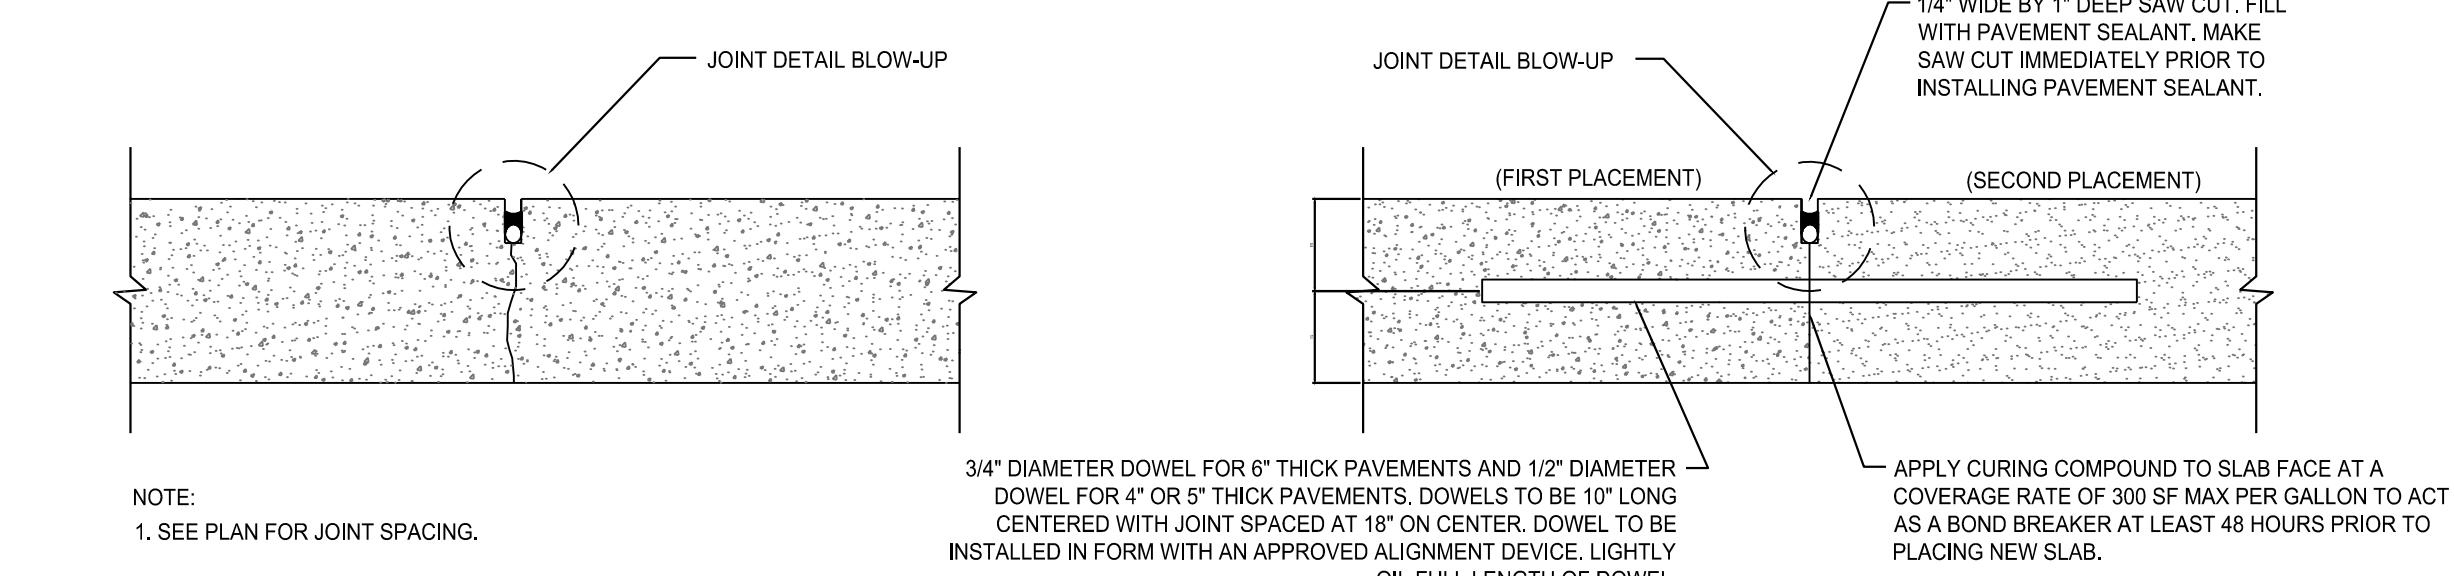


CONSTRUCTION JOINT TO EXISTING PAVEMENT

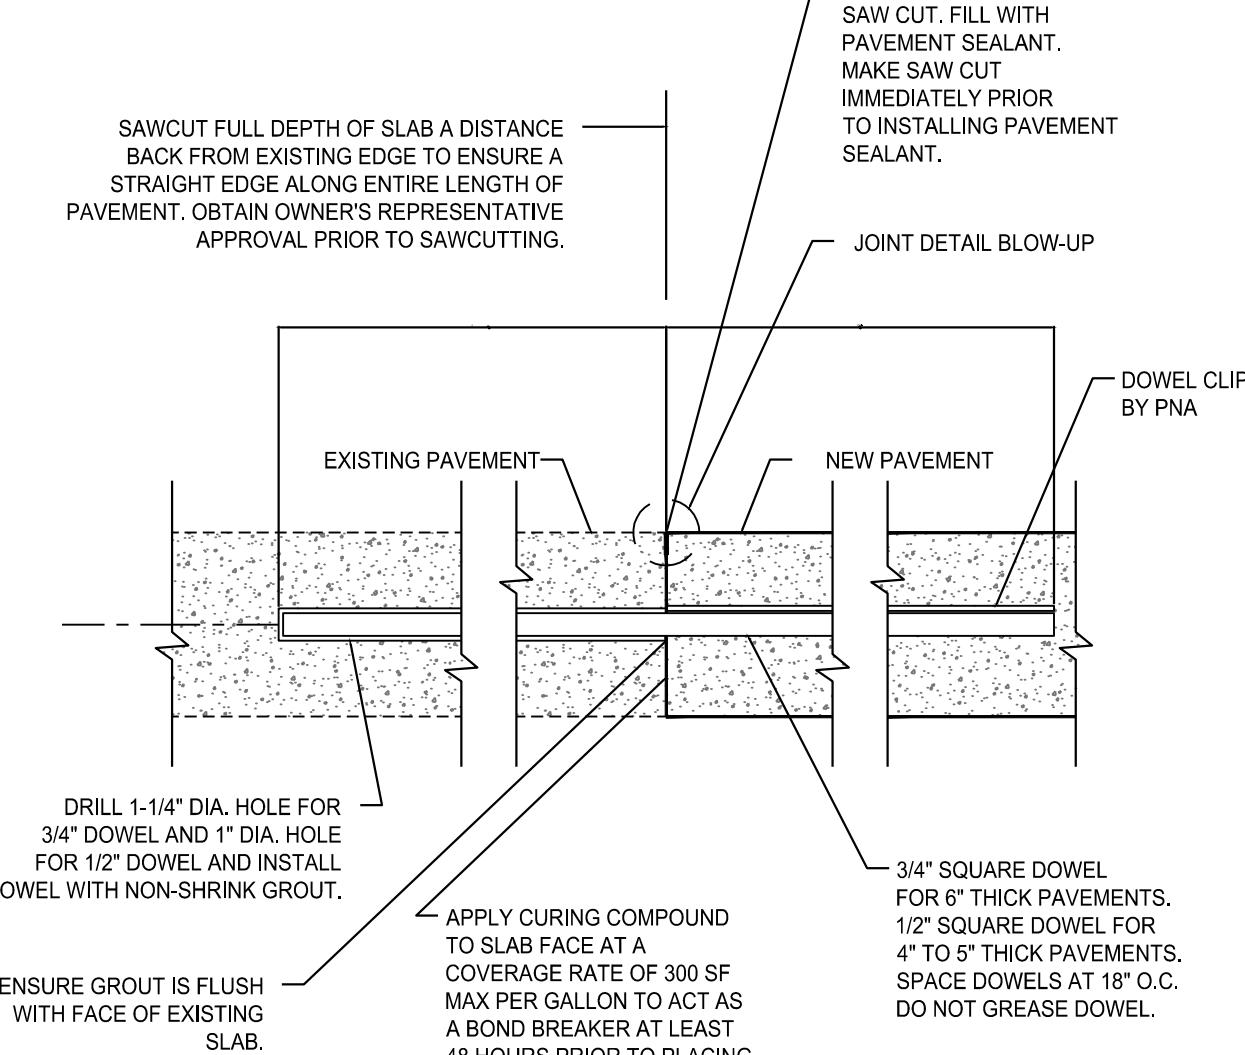


FLUSH CURB AT PAVEMENT

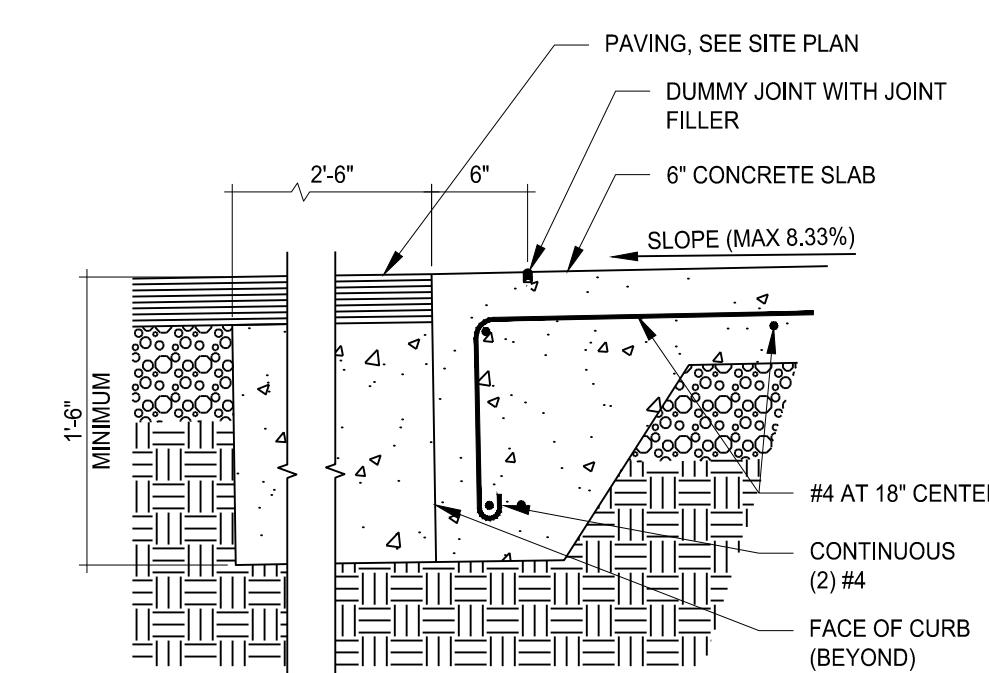SCALE: NTS

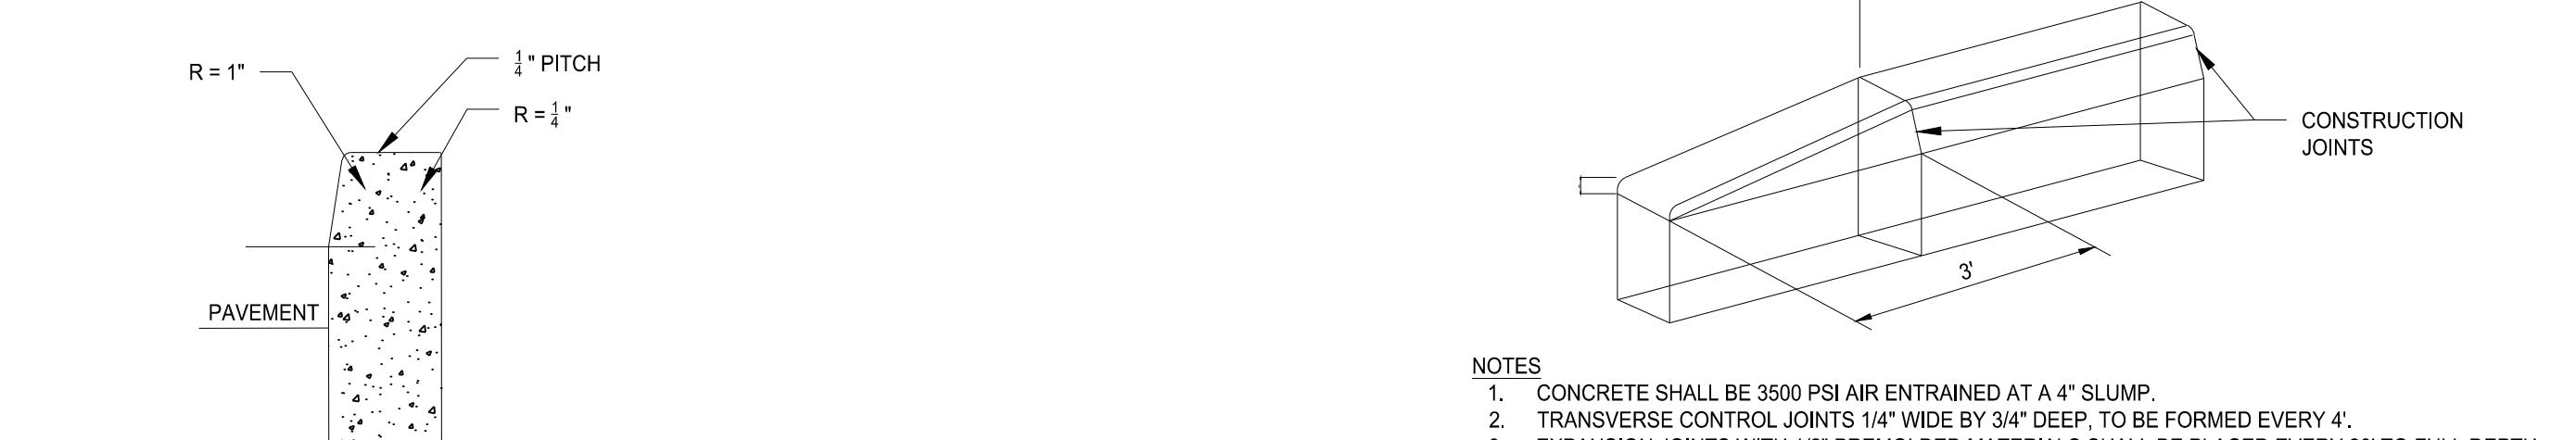

CONCRETE CURBING

DETAIL PER TOWN OF MONROE STANDARDS

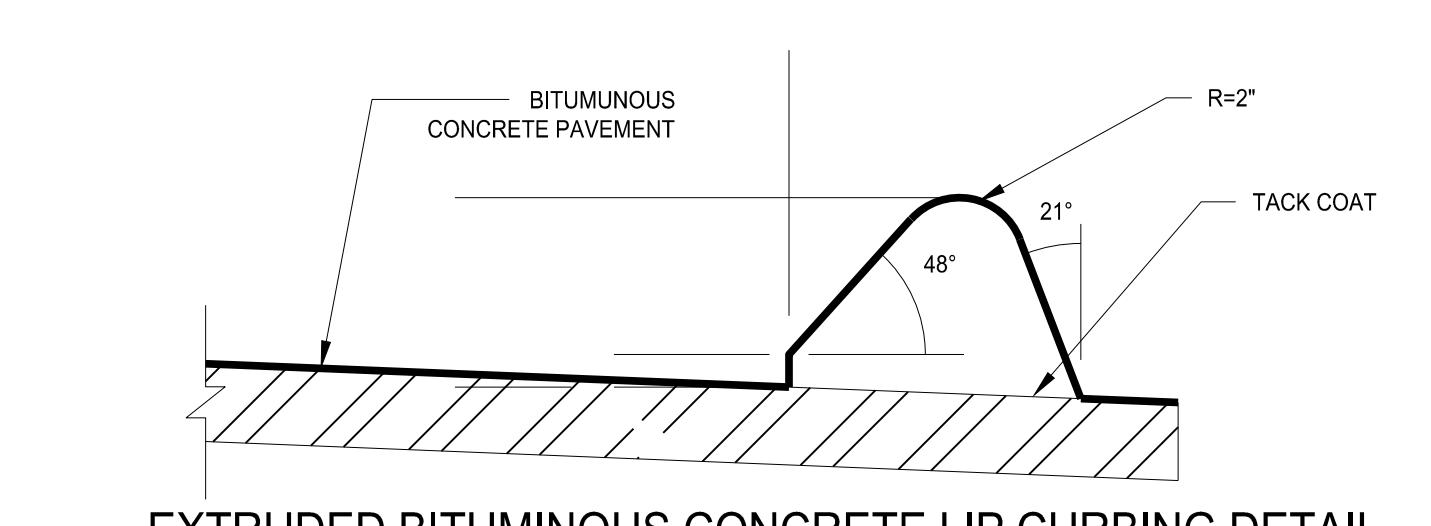

SCALE: NTS



DETAIL PER TOWN OF MONROE DPW STANDARD DRAWINGS

NOTES

1. CONCRETE SHALL BE 3500 PSI AIR ENTRAINED AT A 4" SLUMP.
2. TRANSVERSE CONTROL JOINTS 1/4" WIDE BY 3/4" DEEP, TO BE FORMED EVERY 28' TO FULL DEPTH.
3. EXPANSION JOINTS WITH 1/2" PREMOLDED MATERIALS SHALL BE PLACED EVERY 28' TO FULL DEPTH.
4. WEATHER PROTECTION AND CURING COMPOUNDS SHALL BE USED IN ACCORDANCE WITH CT DOT SPECIFICATIONS.
5. ALL EDGES SHALL BE ROUNDED WITH A 1/4" EDGE TOOL.

CURB TRANSITION DETAIL


SCALE: NTS

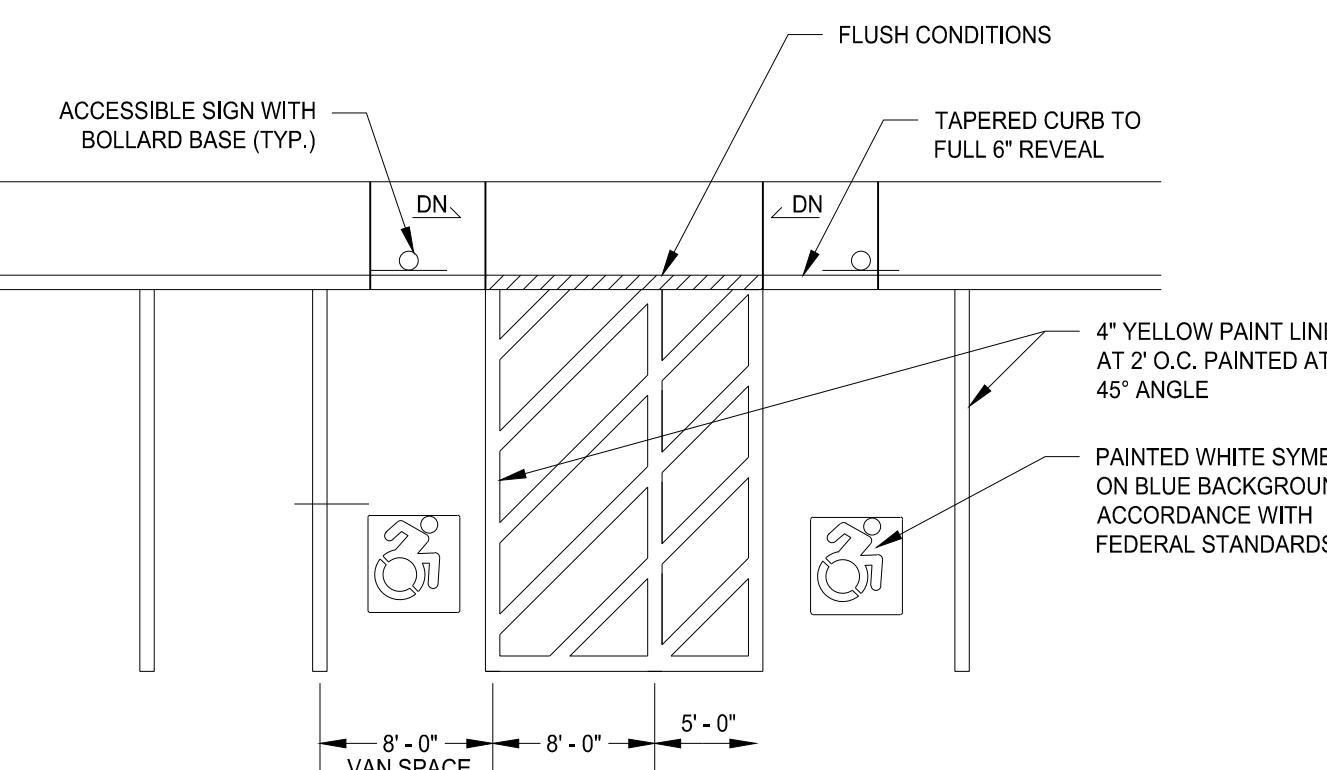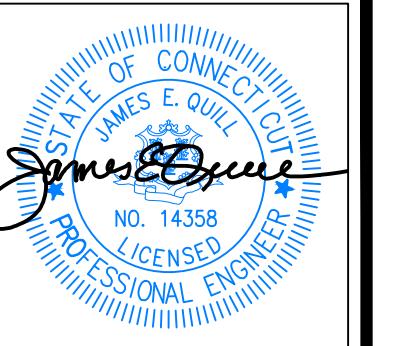

NOTES
1. SEE SITE PLAN FOR ACCESSIBLE SPACE LOCATIONS
2. PROVIDE 2 COATS OF PAINT ON ALL SURFACES.

TYPICAL ACCESSIBLE PARKING SPACE DETAIL


SCALE: NTS

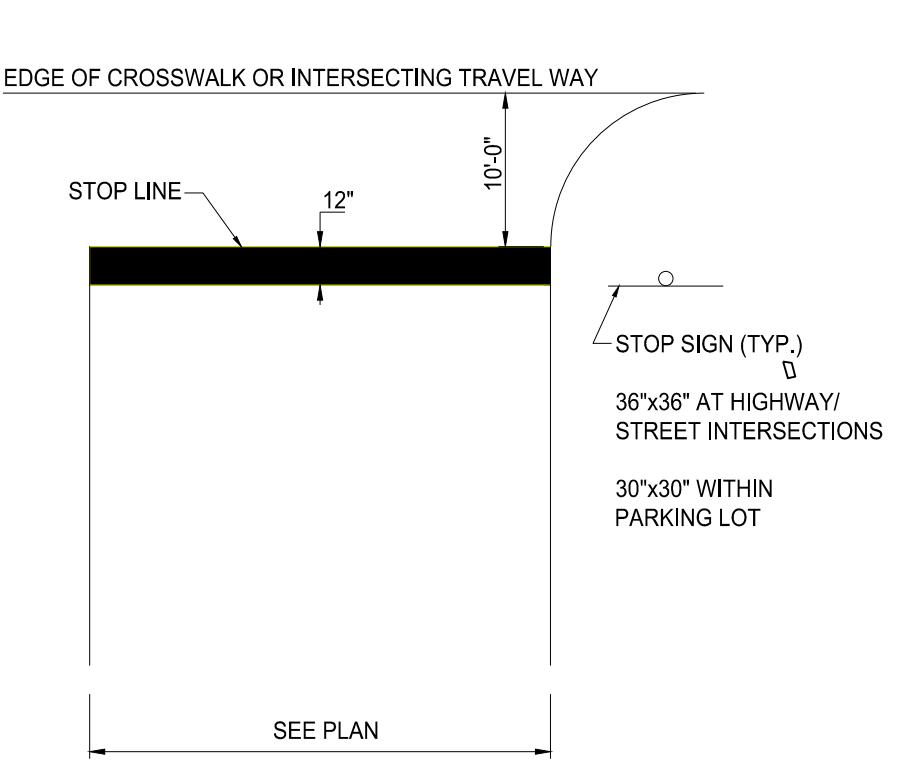

NOTE:
1. WORDS AND LINES SHALL BE APPLIED IN ACCORDANCE WITH SECTIONS 3B.16 AND 3B.20 OF THE MANUAL ON UNIFORM TRAFFIC CONTROL DEVICES FOR STREETS AND HIGHWAYS.
2. THESE WORDS AND BAR ARE TO BE PAINTED RETROREFLECTIVE WHITE.

STOP SIGNAGE AND MARKING


SCALE: NTS

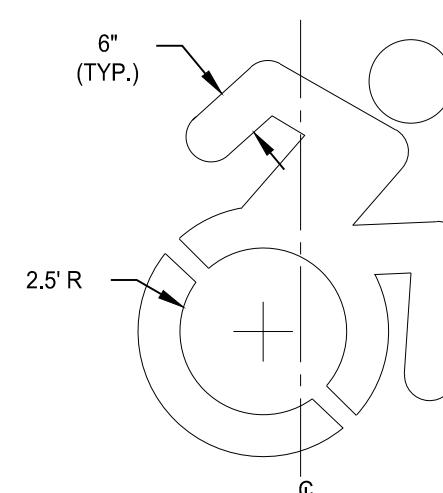

NOTES:
LOCATE AT EDGE OF PARKING SPACE UNLESS ACCCOMPANIED BY "VAN" LETTERING

ACCESSIBLE PARKING SYMBOL


SCALE: NTS

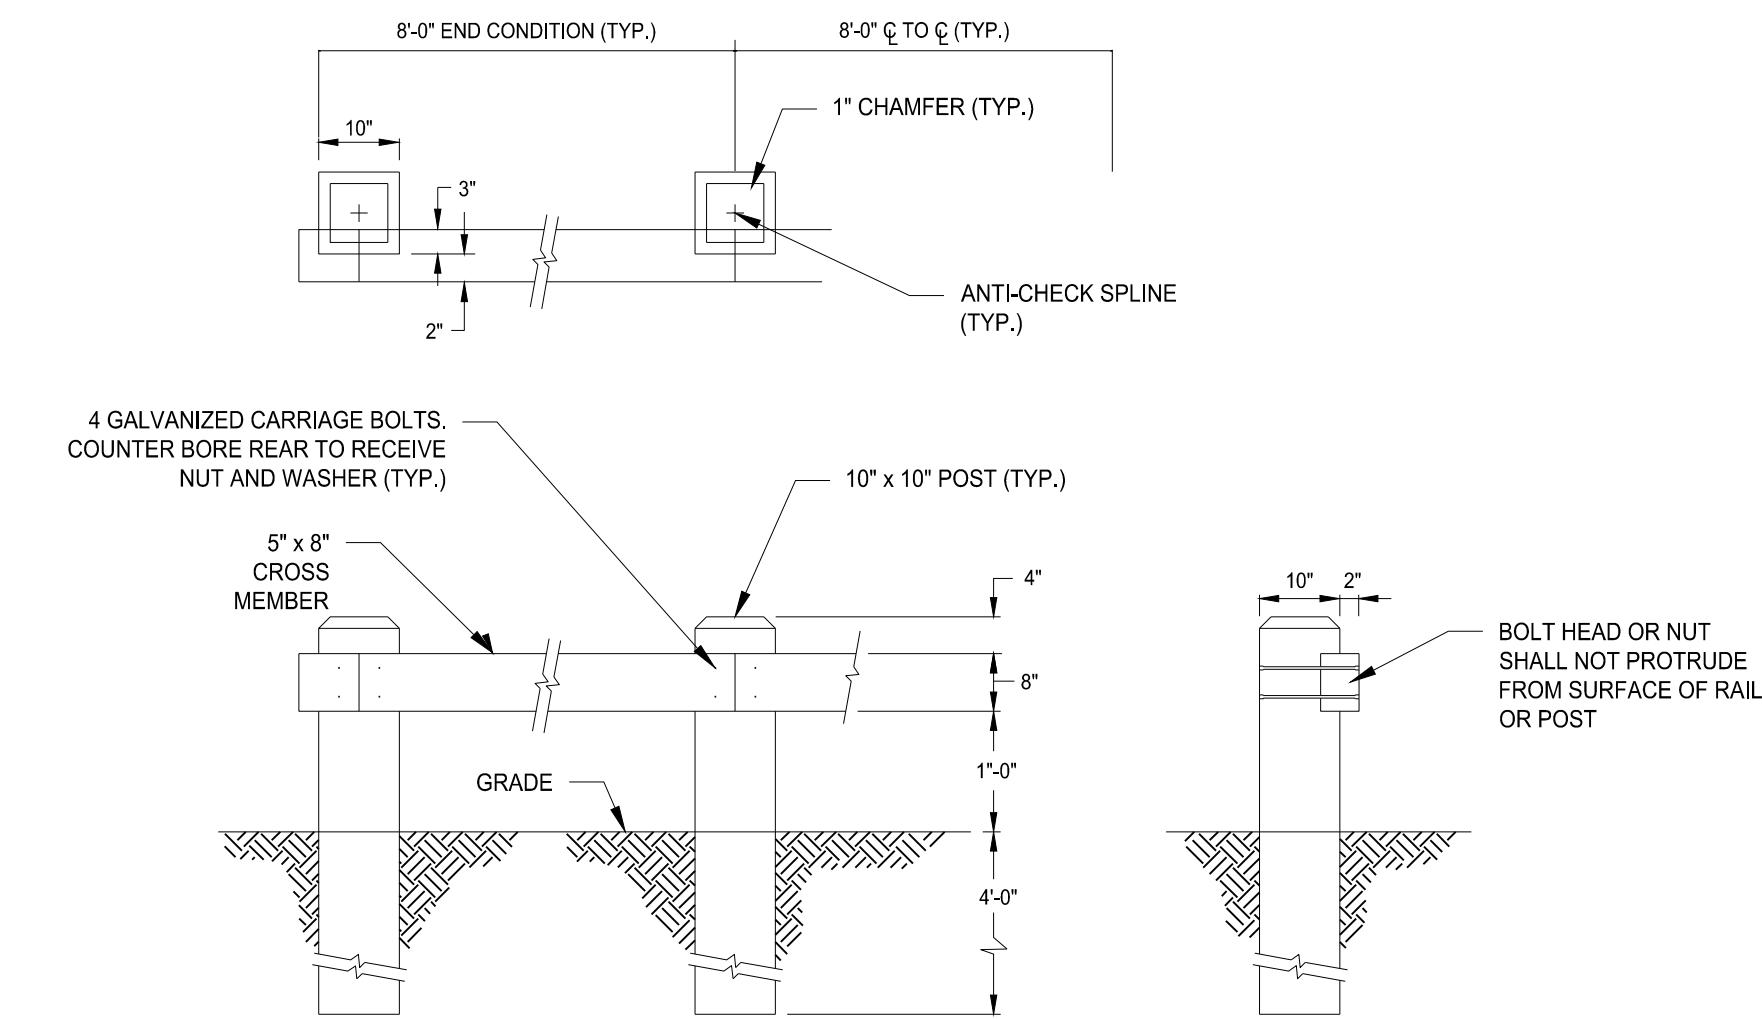

NOTES
1. ALL TIMBER TO BE PRESSURE TREATED CCA=0.40 PCF SOUTHERN YELLOW PINE


TIMBER GUIDE RAIL

SCALE: NTS

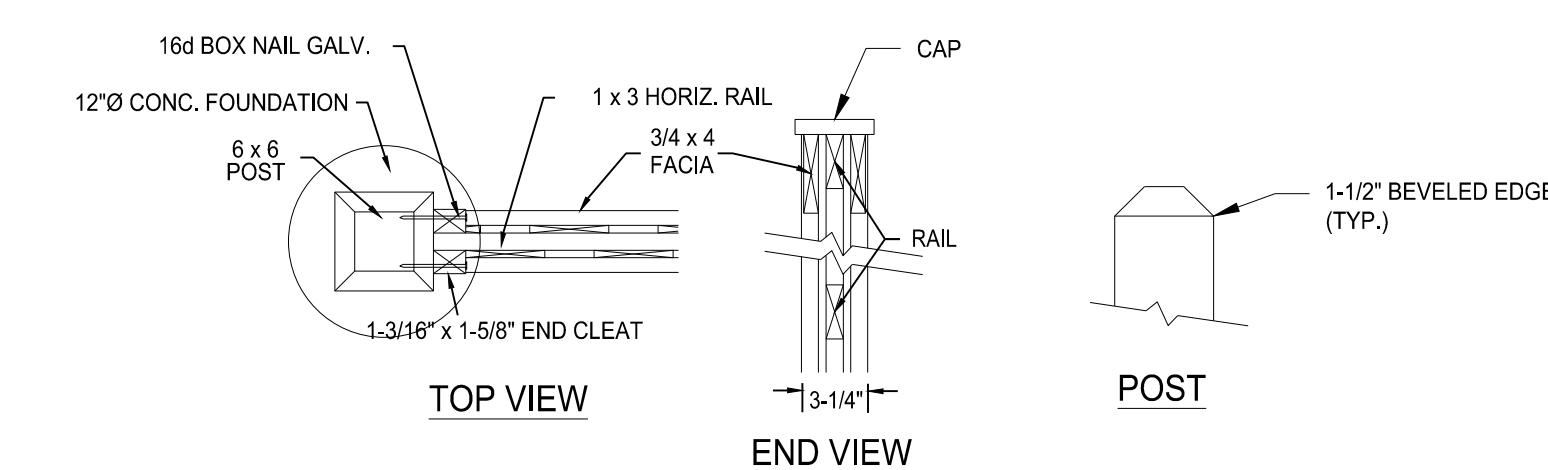


TOP VIEW POST

END VIEW

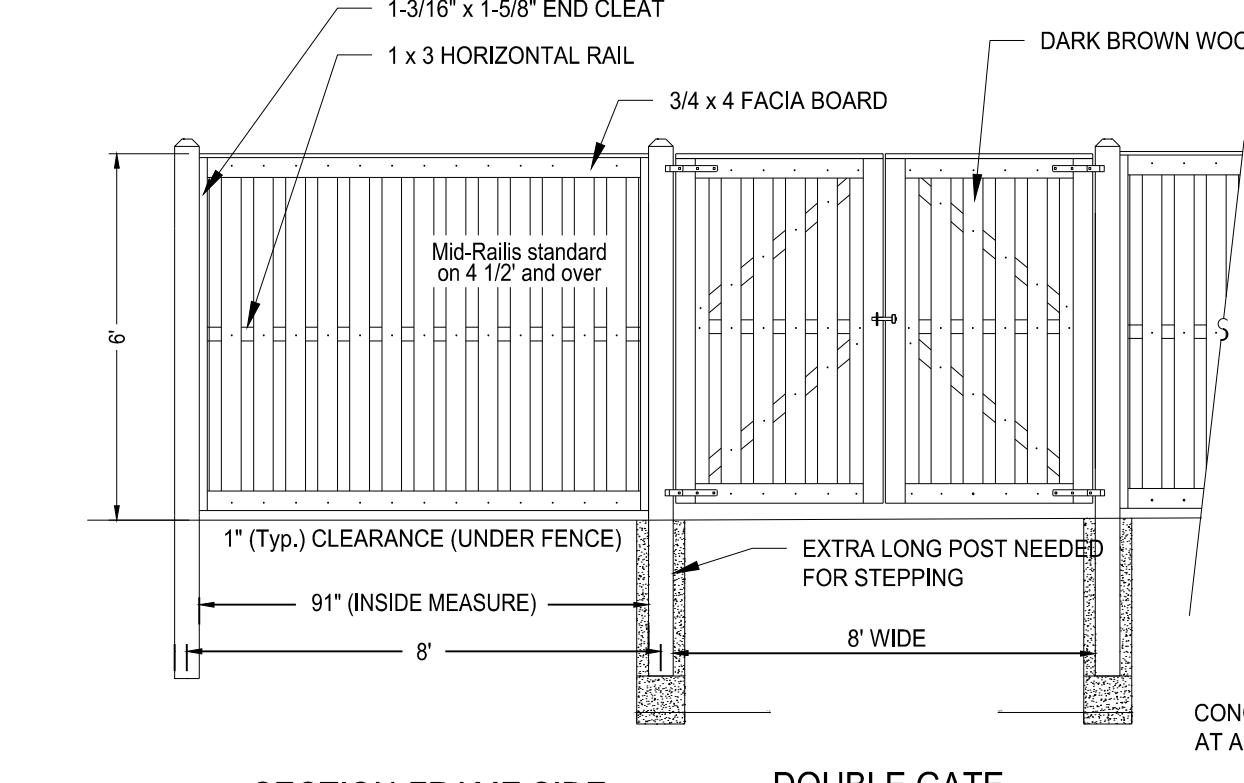


DUMPSTER PAD ENCLOSURE - BOARD ON BOARD FENCE

SCALE: NTS

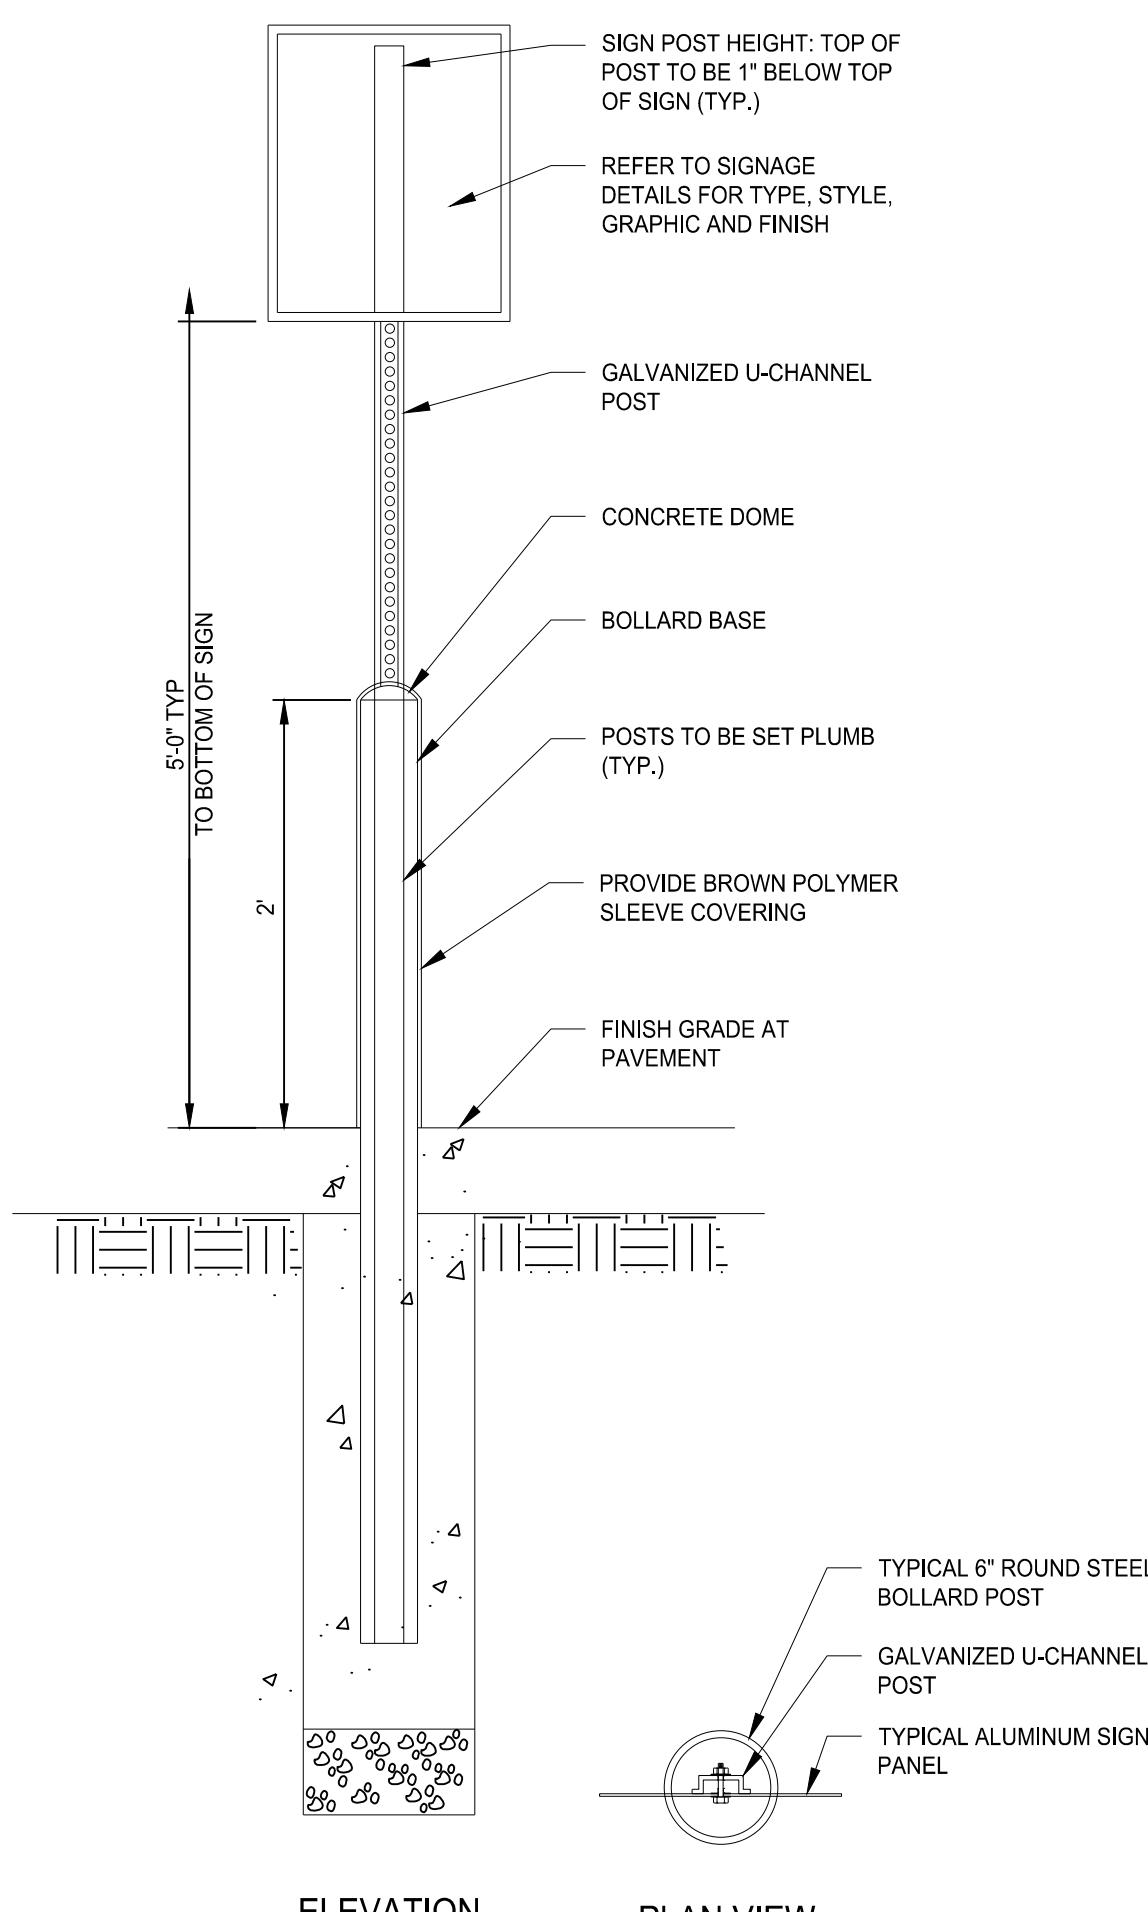


SIGN MOUNTING FOR ACCESSIBLE SIGN

SCALE: NTS

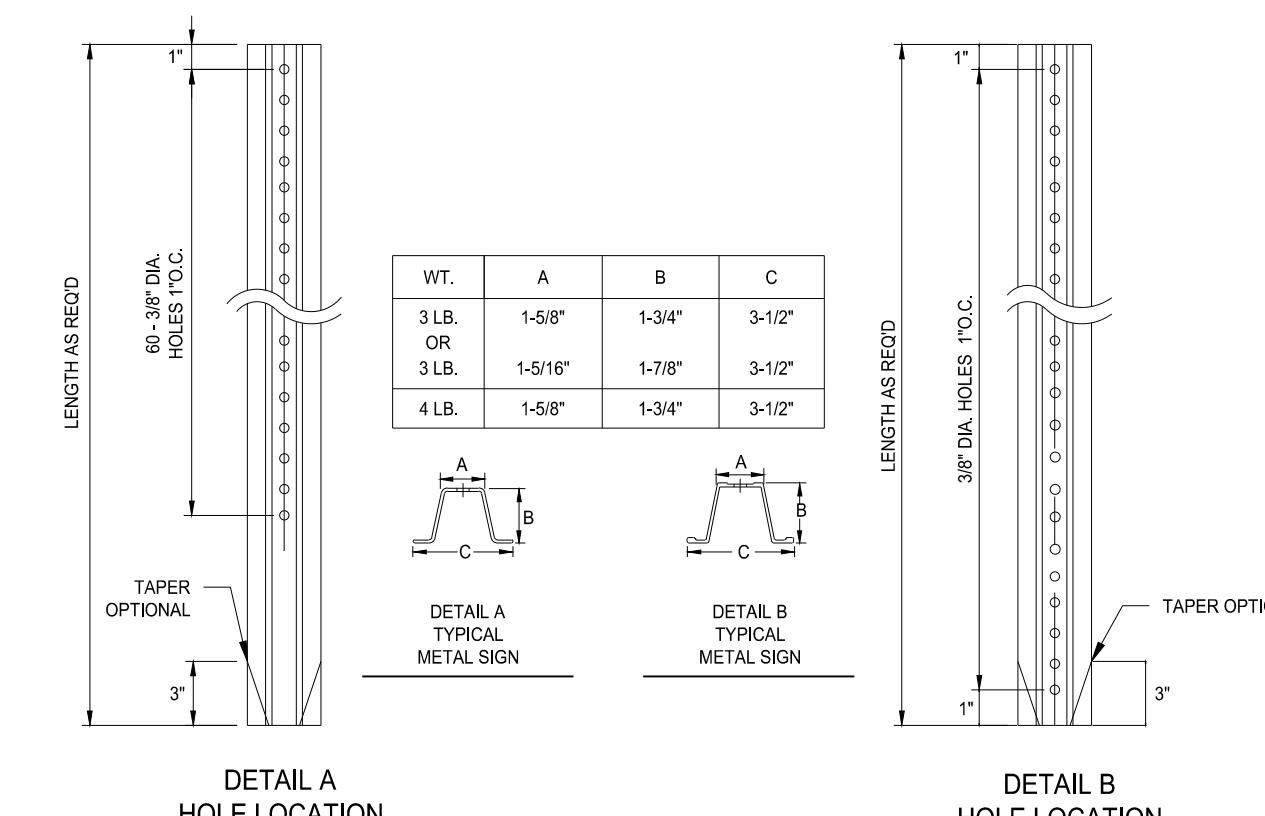

TYPICAL METAL SIGN POSTS

SCALE: NTS

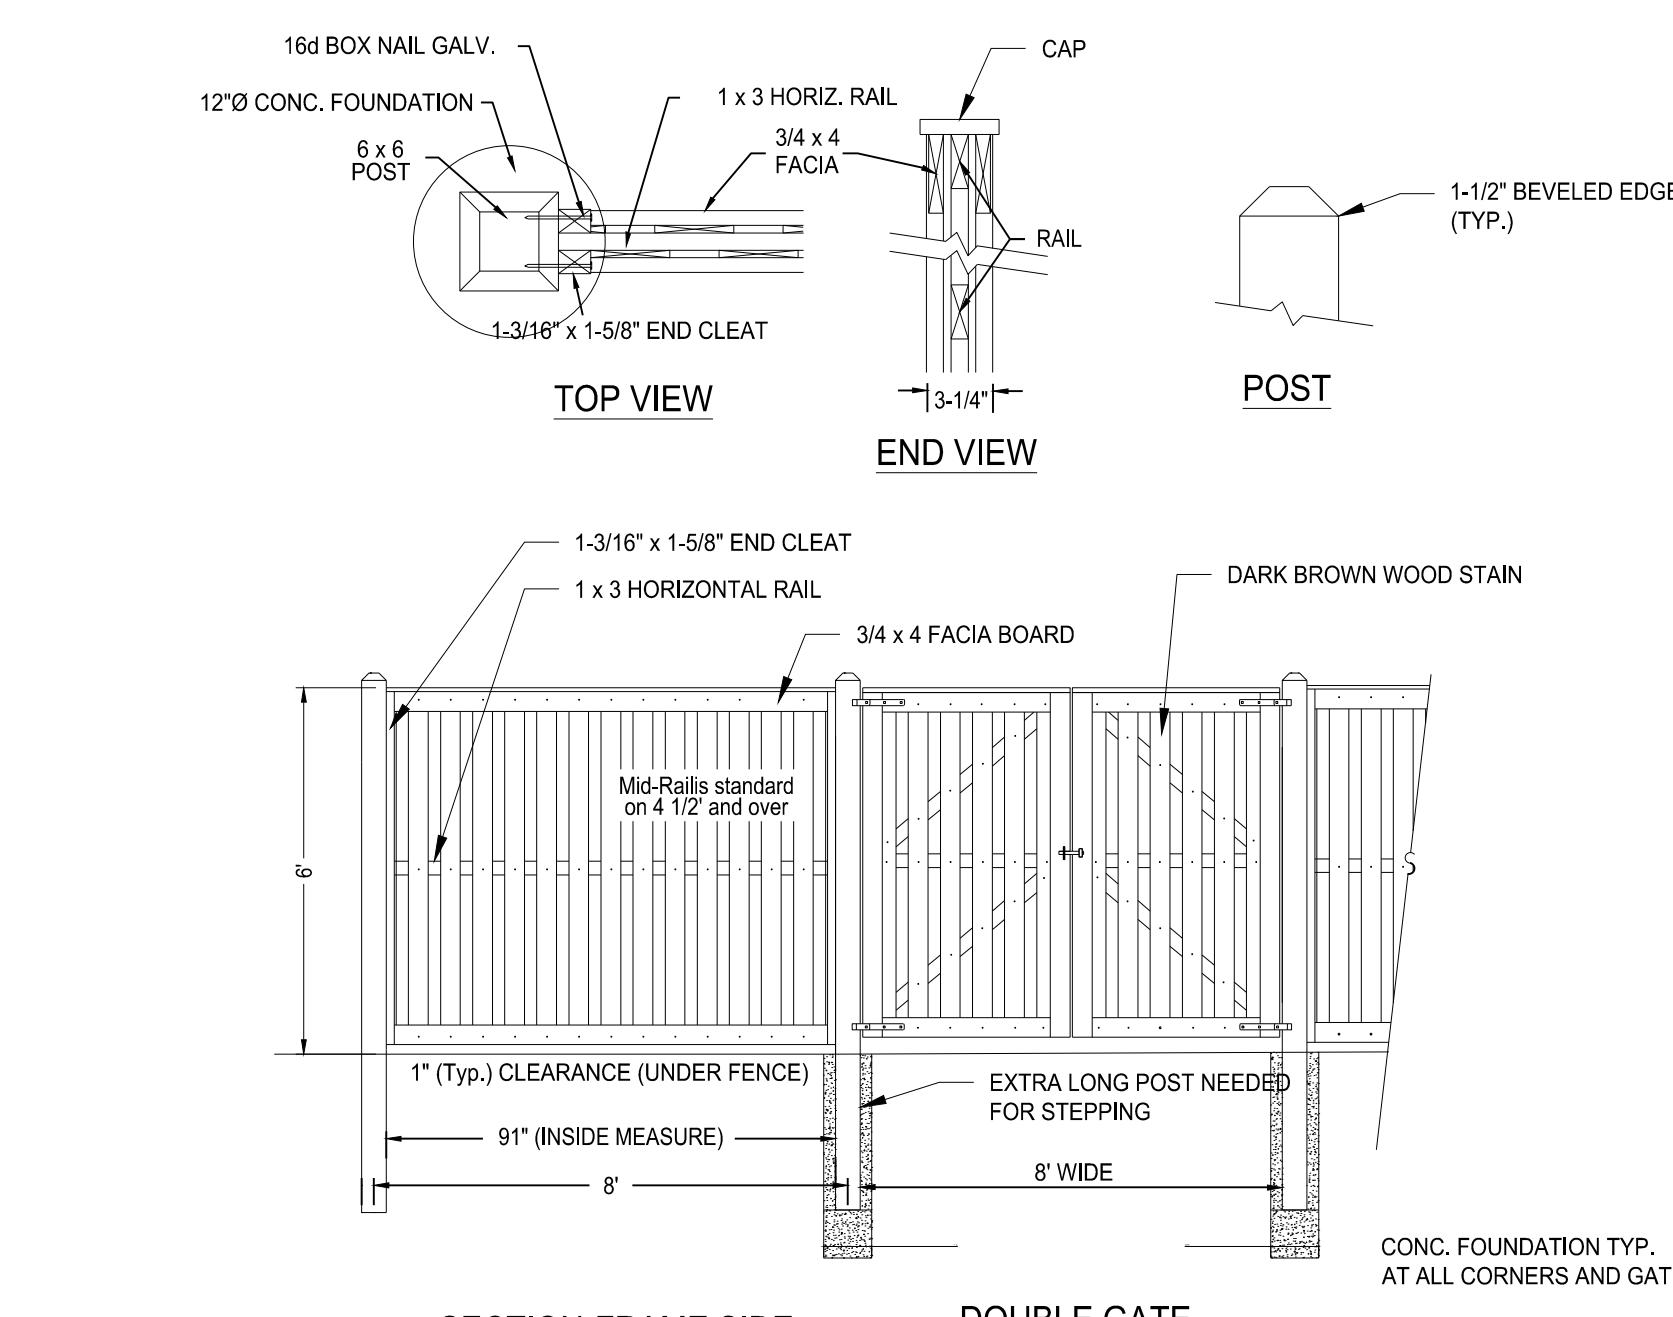

SECTION-FRAME SIDE DOUBLE GATE FRAME SIDE

PROPOSED 100-UNIT MULTIFAMILY
DEVELOPMENT
27 BEECHER ROAD, WOODBRIDGE, CONNECTICUT
PREPARED FOR
BEECHER ROAD, LLC

Job Number:
FE25-1960

Job Start Date:
4-15-25

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ISSUED	XXX
Staff Comments	1/19/26
Level Spreader Mod	11/20/25
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Sheet Title:
DETAIL SHEET

Scale:

Sheet Number:
C-6.3